




INTERIOR ELEVATION AA  
SCALE 1/8" = 1'0"

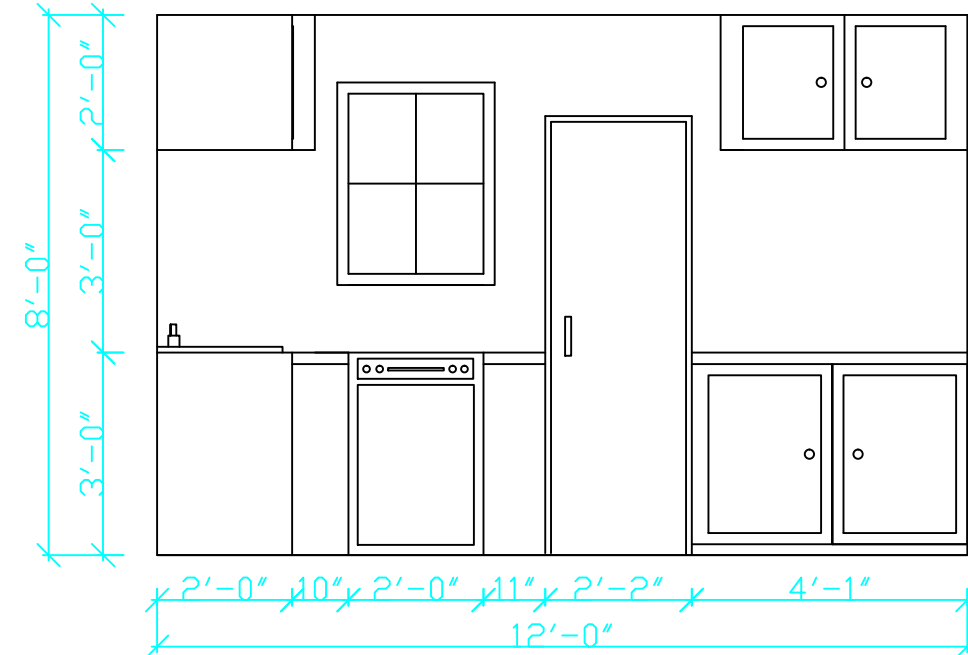


INTERIOR ELEVATION BB  
SCALE 1/8" = 1'0"

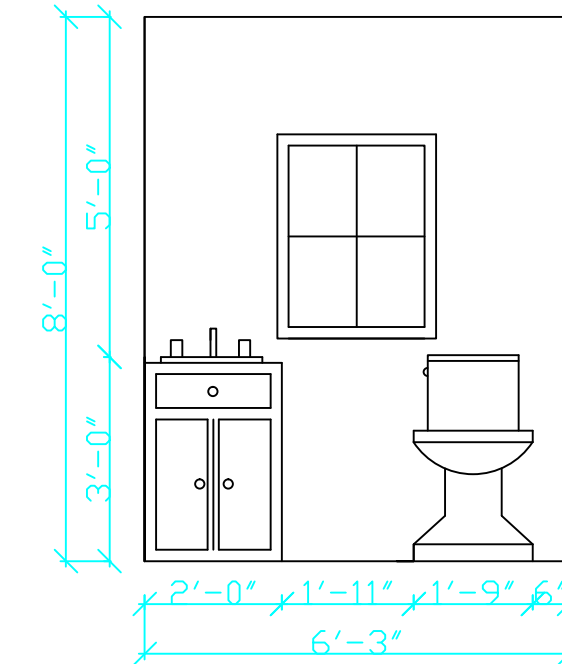


INTERIOR ELEVATION CC  
SCALE 1/8" = 1'0"

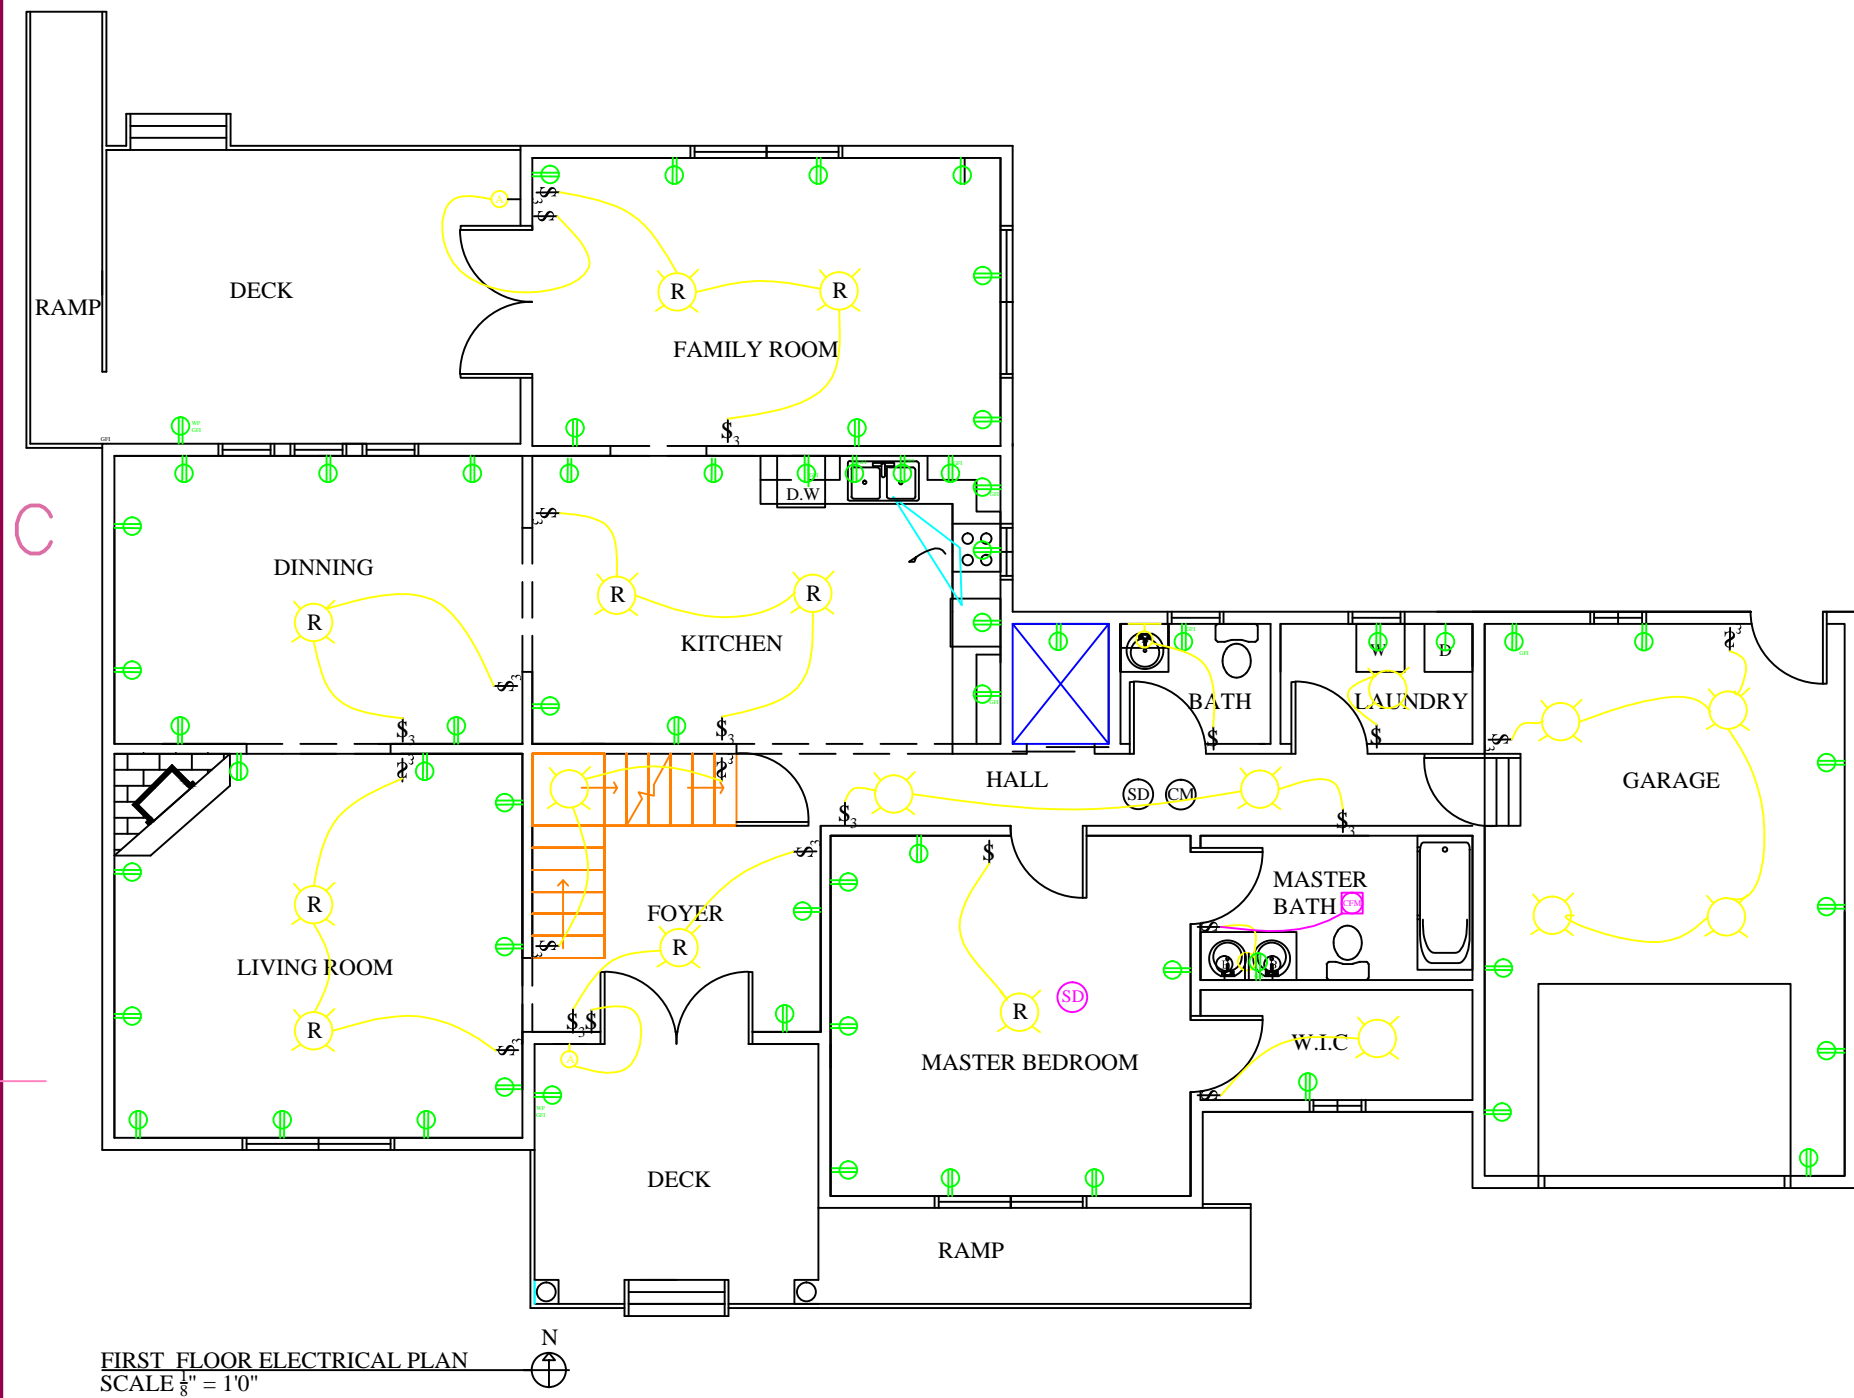

FIRST FLOOR ELECTRICAL PLAN  
SCALE 1/8" = 1'0"

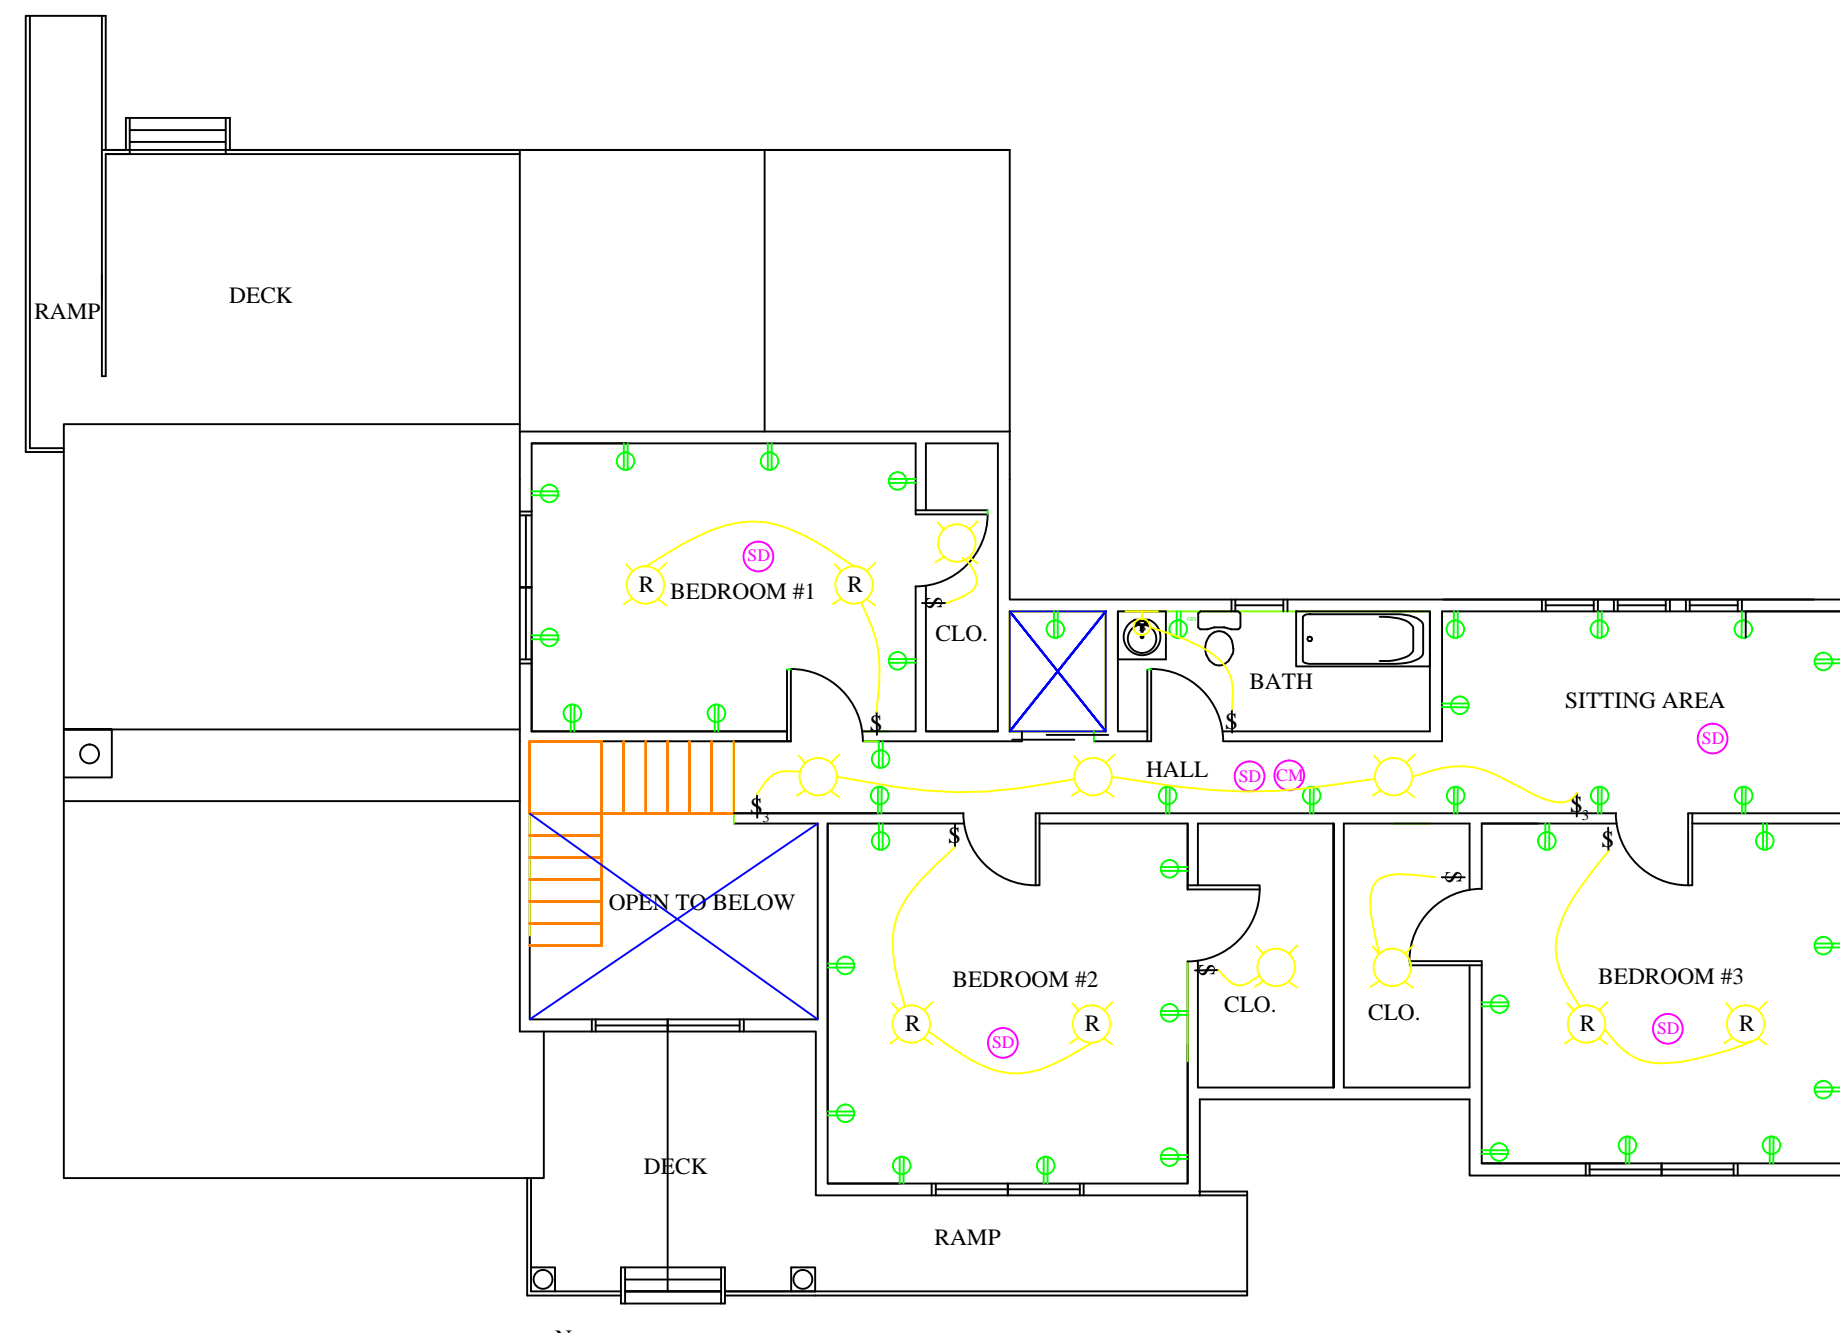

SECOND FLOOR ELECTRICAL PLAN  
SCALE 1/8" = 1'0"

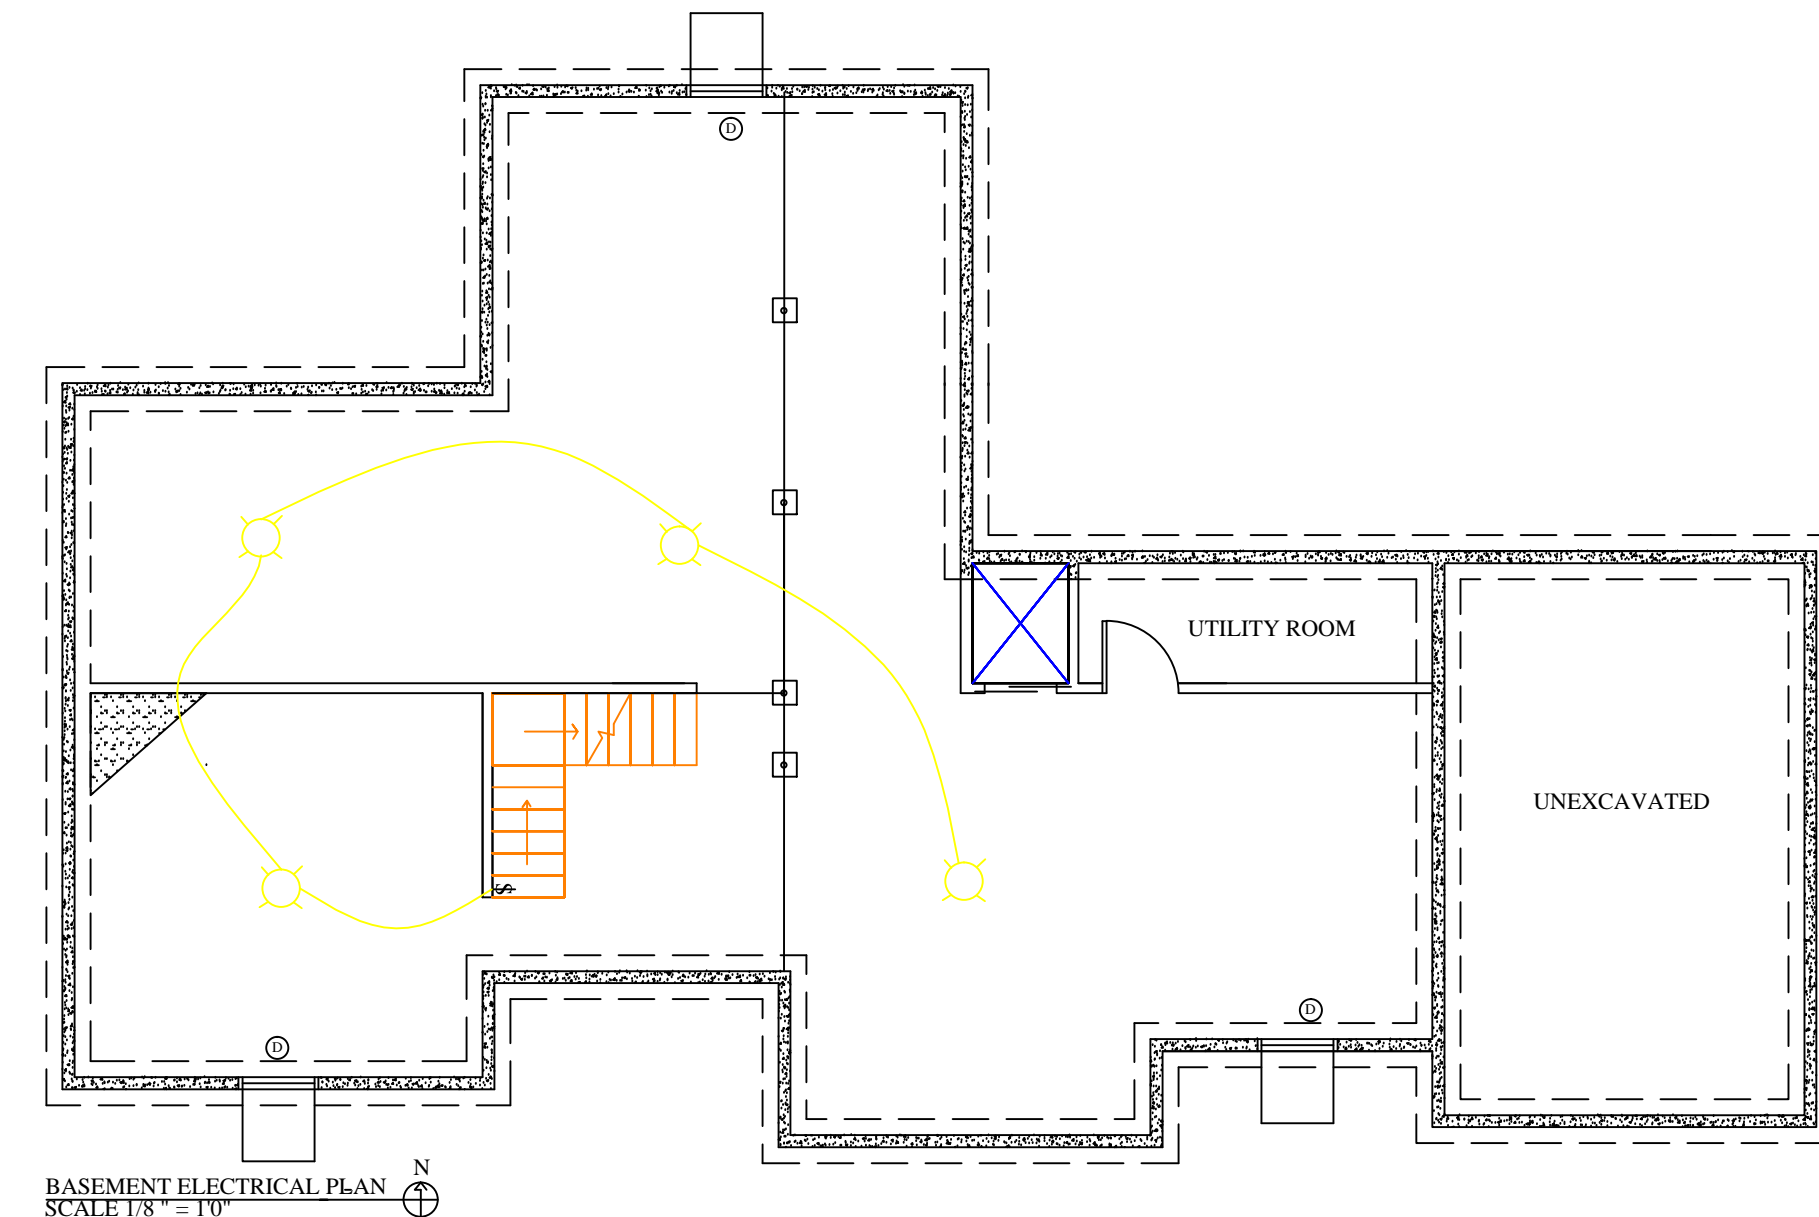


BASEMENT ELECTRICAL PLAN  
SCALE 1/8" = 1'0"

INTERIOR FINISH SCHEDULE

ROOM	FLOOR	BASE	WALLS	CEILING	AREA								
	CARPET	TILE	WOOD	LINOLIUM	CONCRETE	WOOD	NYL TOPSET	CONCRETE	GYPSUM BOARD	TYPE X GYPSUM	CEILING HEIGHT	GYPSUM BOARD	SQUARE FOOTAGE
FOYER											18'-0"		138
LIVING ROOM											9'-0"		272
DINING ROOM											9'-0"		204
FAMILY ROOM											9'-0"		234
KITCHEN											9'-0"		234
MASTER BEDROOM											9'-0"		225
MASTER BATHROOM											9'-0"		68
MASTER W.I.C											9'-0"		52
BATHROOM #1											9'-0"		31.25
LAUNDRY ROOM											9'-0"		40
GARAGE											9'-0"		345
HALLWAY											9'-0"		84
BEDROOM #1											9'-0"		234
BEDROOM #2											9'-0"		320
BEDROOM #3											9'-0"		307
BATHROOM #2											9'-0"		65
SITTING AREA											9'-0"		140
HALLWAY											9'-0"		88.5

ELECTRICAL KEY

⊕	TWO WAY SWITCH
⊕	THREE WAY SWITCH
⊕	DRYER RECEPTACLE
⊕	DUPLEX RECEPTACLE
⊕	DUPLEX GROUND FAULT RECEPTACLE
⊕	WATERPROOF GROUND FAULT INTERRUPTER RECEPTACLE
⊕	HOMERUN TO SERVICE PANEL
⊕	SERVICE PANEL
⊕	RECESS MOUNTED FIXTURE
⊕	CEILING MOUNTED FIXTURE
⊕	EXTERIOR WALL MOUNTED FIXTURE
⊕	INTERIOR WALL MOUNTED FIXTURE
⊕	SMOKE DETECTOR
⊕	CARBON MONOXIDE DETECTOR
⊕	EXHAUST VENT TO EXTERIOR
⊕	EMERGENCY BOILER SHUT-OFF SWITCH

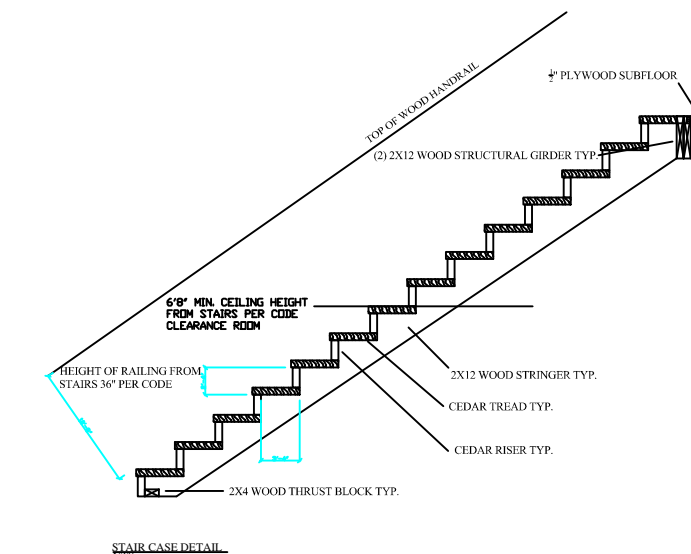


DOOR SCHEDULE

SYM.	WIDTH	HEIGHT	THK.	TYPE	MATERIAL	GLAZ. AREA	REMARKS
①	6'-4"	7'-0"	1 1/2"	EXTERIOR	WOOD	3.64sq'	EXTERIOR WALL MOUNTED FIXTURE
②	3'-0"	6'-6"	1 1/2"	INTERIOR	WOOD		INTERIOR WALL MOUNTED FIXTURE
③	6'-4"	7'-0"	1 1/2"	EXTERIOR	WOOD/GLASS	3.64sq'	SMOKE DETECTOR
④	3'-0"	6'-6"	1 1/2"	INTERIOR	WOOD		CARBON MONOXIDE DETECTOR
⑤	3'-0"	7'-0"	1 1/2"	EXTERIOR	WOOD		EXHAUST VENT TO EXTERIOR

WINDOW SCHEDULE

SYM.	WIDTH	HEIGHT	TYPE	FRAME	SCREEN	GLAZ. AREA	VENT AREA	REMARKS
Ⓐ	6'-4"	5'-0"	DOUBLE-HUNG	WOOD	YES	12.39sq'	12.39sq'	2 WIDE DOUBLE HUNG ANDERSON 400 SERIES
Ⓑ	2'-4"	3'-0"	CASEMENT	WOOD	YES	23.0sq'	11.50sq'	ANDERSON 100 SERIES LOW-E GLASS
Ⓒ	2'-4"	6'-0"	CASEMENT	WOOD	YES	19.41sq'	9.70sq'	ANDERSON 100 SERIES LOW-E GLASS
Ⓓ	4'-4"	1'-2"	AWNING	WOOD	YES	8.0sq'	4.0sq'	ANDERSON 100 SERIES AWNING WINDOW. EGRESS WINDOW FOR BASEMENT

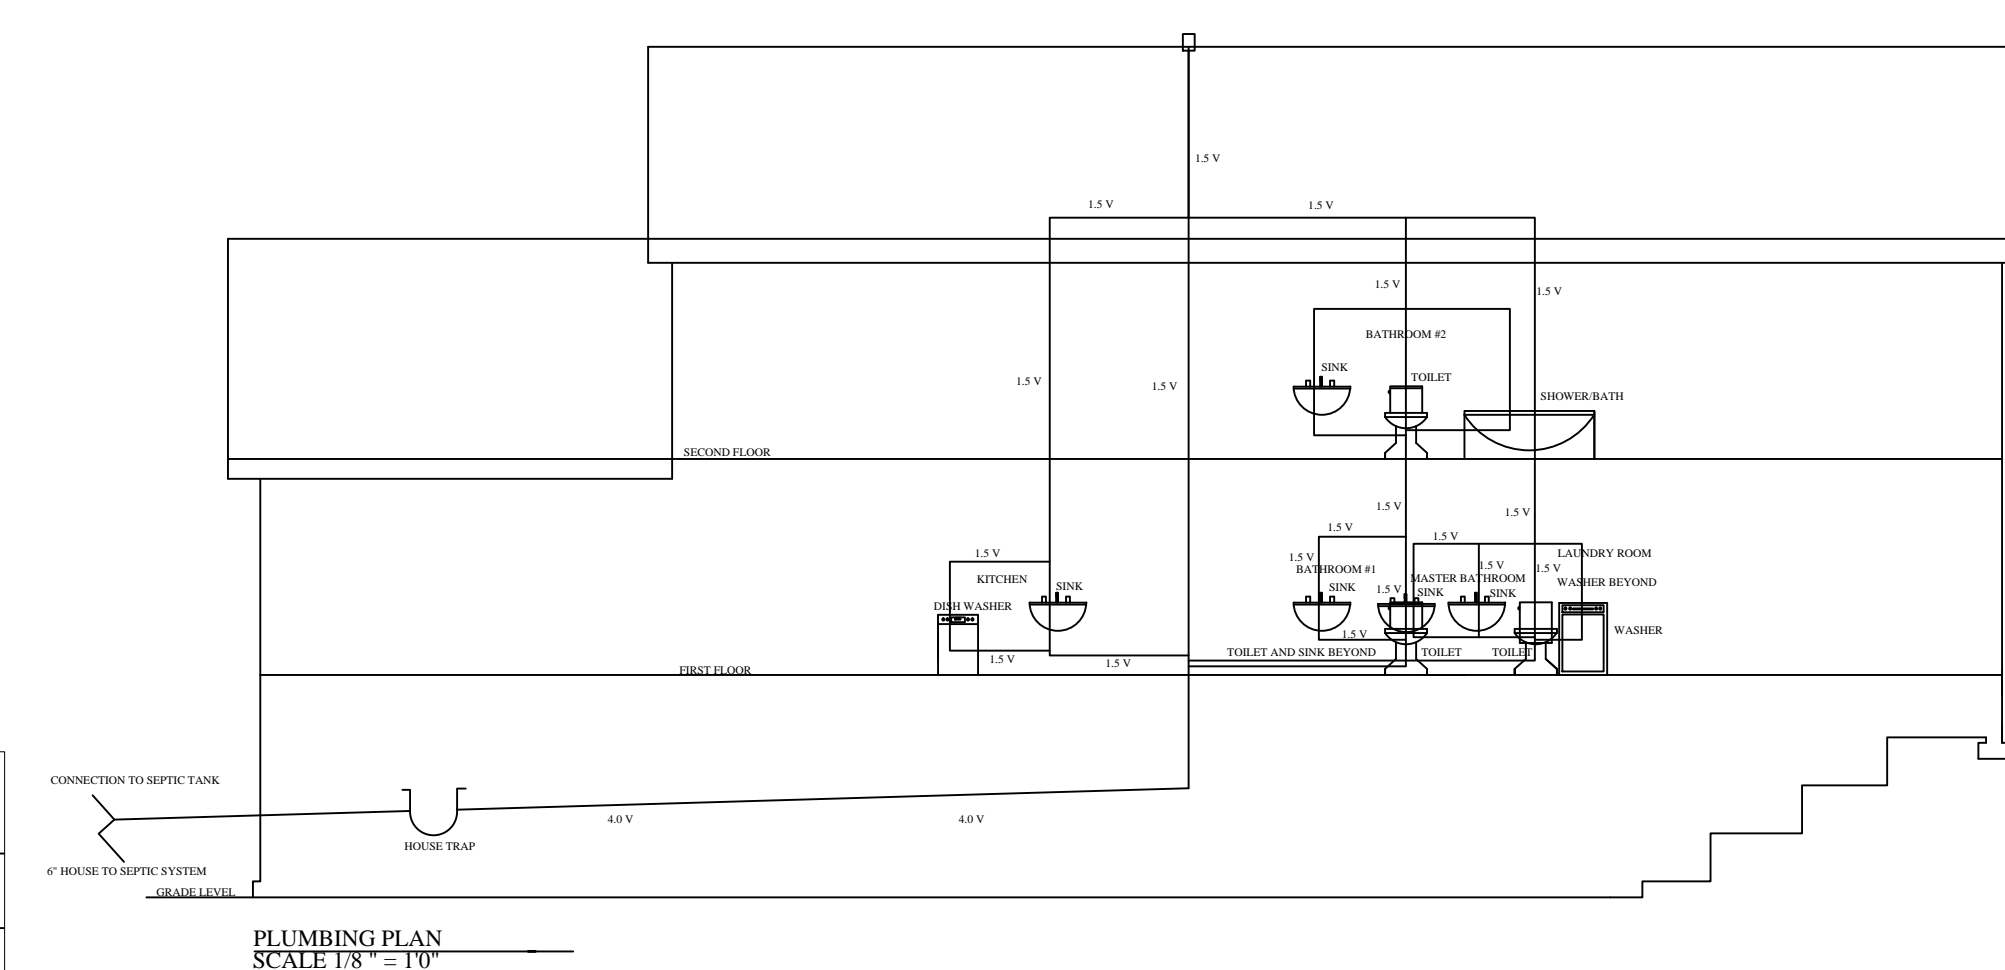

PLUMBING PLAN  
SCALE 1/8" = 1'0"

CONSULTANTS

.\fsc-logo-rgb new.jpg

US IMPERIAL  
PROJECT STREET  
OWNER  
CLIENT'S NAME  
Client Street

MARK DATE DESCRIPTION


PROJECT NO: 1  
CAD DWG FILE: MP RESIDENTIAL HOUSE.DWG  
DRAWN BY: MEGAN PISCIOTTA  
CHK'D BY: ###  
COPYRIGHT:

CONSTRUCTION DESIGN  
SPRING 2014: PROJECT 1



A-04

SHEET SHEET INDEX OF TOTAL SHEETS




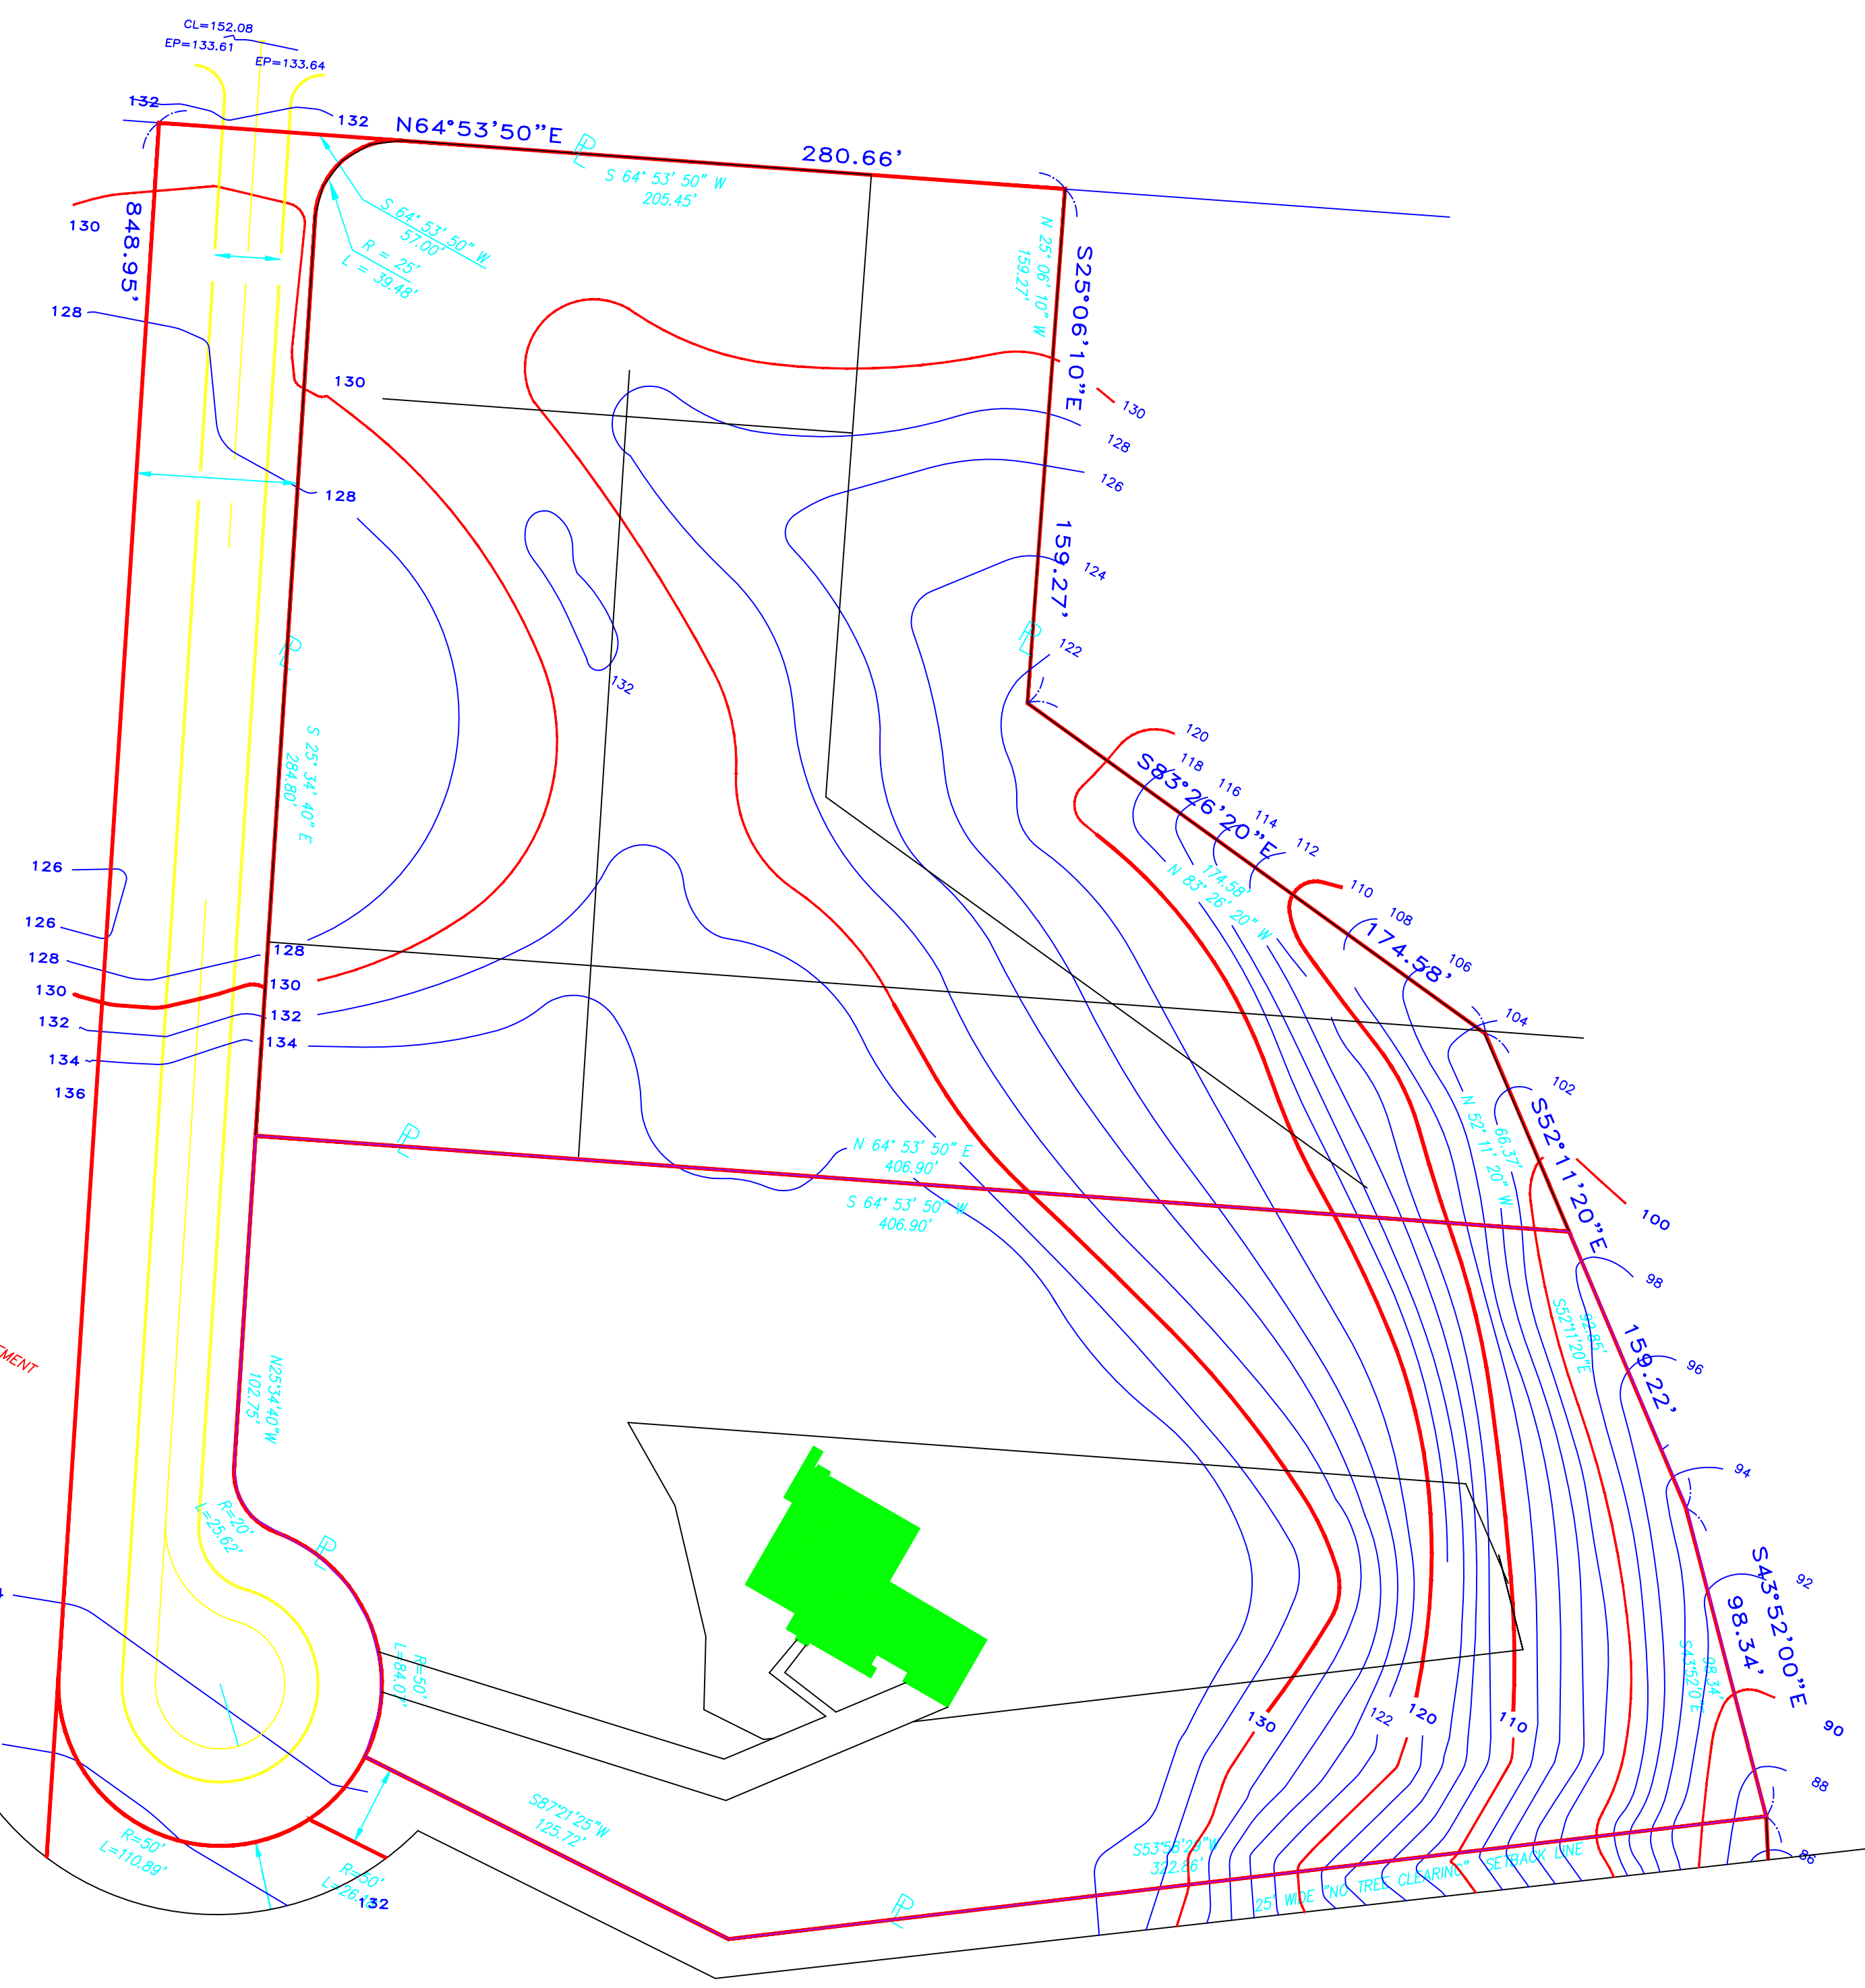

SITE PLAN  
SCALE: 1"=40'0"

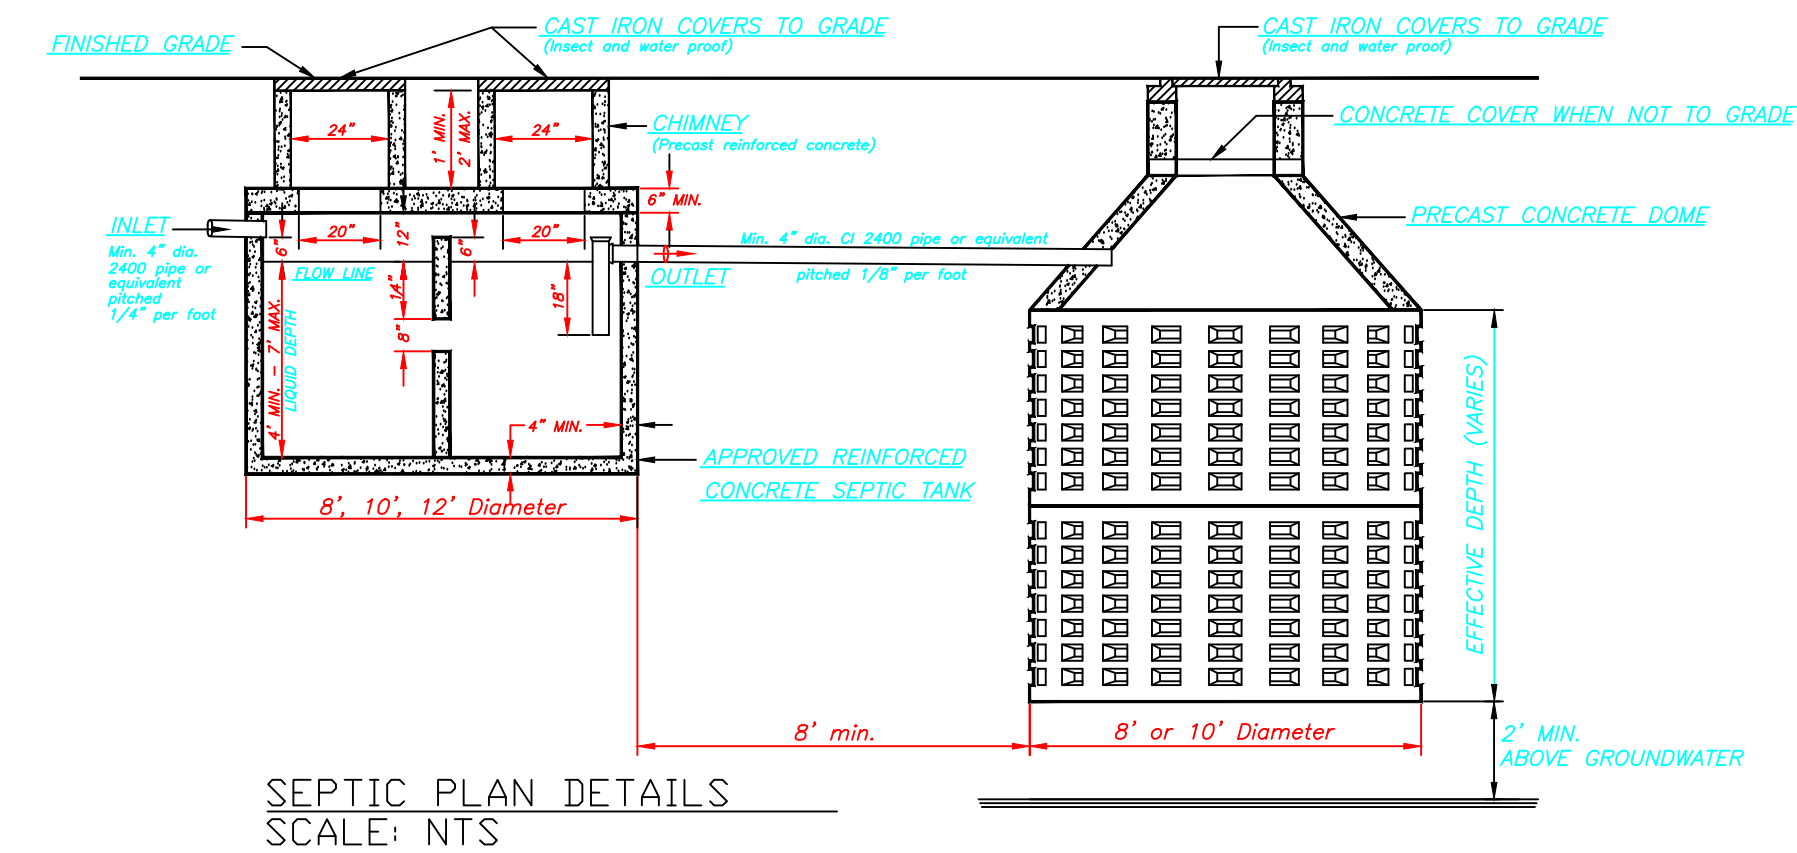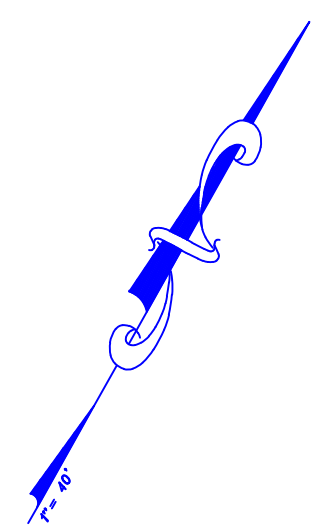

SEPTIC PLAN DETAILS  
SCALE: NTS

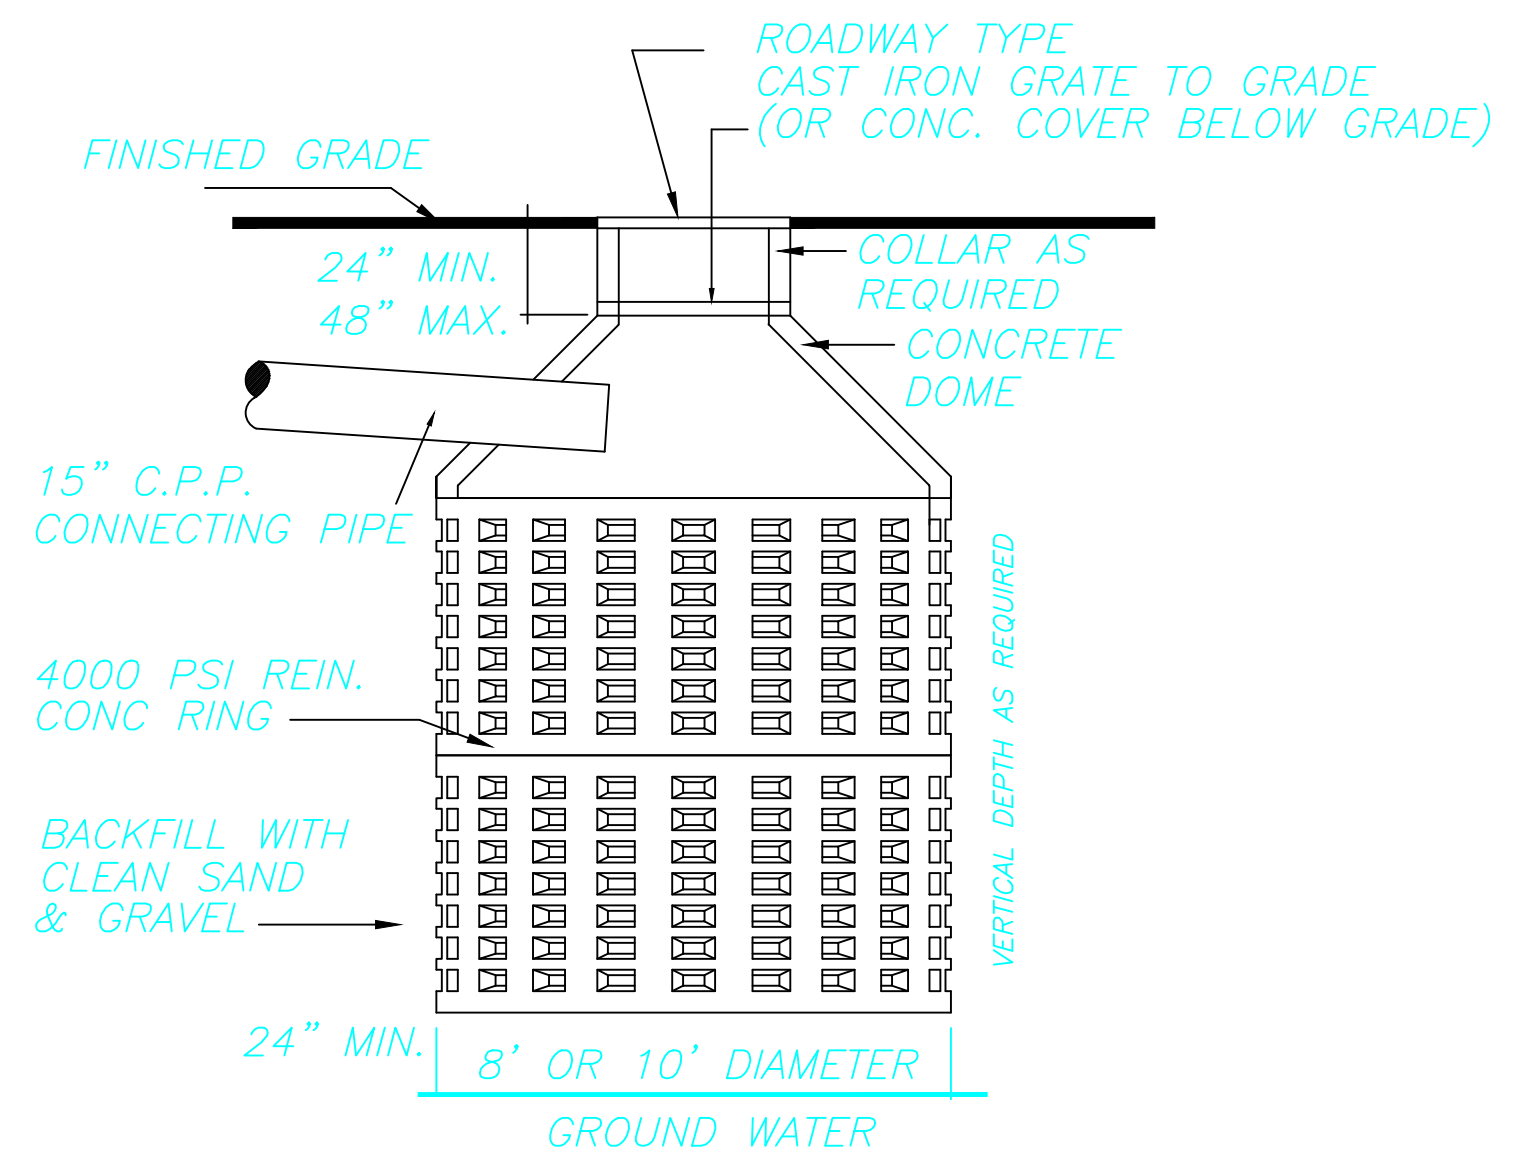

SEPTIC PLAN DETAILS  
SCALE: NTS

SYMBOLS

- CONCRETE
- VINYL SIDING
- SOUTHERN HEARTHSTONE
- EARTH
- FINISH WOOD
- RIGID INSULATION
- GRAVEL
- BATT INSULATION
- BLOCKING OR ROUGH WOOD
- PROPERTY LINE
- ELEVATION INTERVAL
- OPEN TO BELOW
- ROOF EAVE
- FOUNDATION FOOTING
- STRUCTURAL BEAM
- SECTION DESIGNATION DRAWING NUMBER
- BUILDING SECTION DESIGNATION DRAWING NUMBER
- DETAIL DESIGNATION DRAWING NUMBER
- ELEVATION
- REVISION CLOUD
- WINDOW TYPE DESIGNATION
- DOOR TYPE DESIGNATION
- BEAM TYPE DESIGNATION

GROUND SNOW LOAD	WIND SPEED (mph)	SEISMIC DESIGN CATEGORY	SUBJECT TO DAMAGE FROM			ICE BARRIER UNDERLAYMENT REQUIRED	FLOOD HAZARDS
			WEATHERING	FRONT LINE DEPT	TERMITE		
20	110	B	SEVERE	3 FT	MOD/HEAVY	YES	YES

CONSULTANTS

.\fsc-logo-rgb new.jpg

US IMPERIAL  
PROJECT STREET

OWNER  
CLIENT'S NAME  
Client Street

MARK DATE DESCRIPTION

PROJECT NO: 1  
CAD DWG FILE: MP RESIDENTIAL HOUSE.DWG  
DRAWN BY: MEGAN PISCIOTTA  
CHK'D BY: ###  
COPYRIGHT:


SHEET TITLE  
CONSTRUCTION DESIGN  
SPRING 2014: PROJECT 1

A-01


SHEET SHEET INDEX OF TOTAL SHEETS

PRODUCED BY AN AUTODESK EDUCATIONAL PRODUCT


PRODUCED BY AN AUTODESK EDUCATIONAL PRODUCT

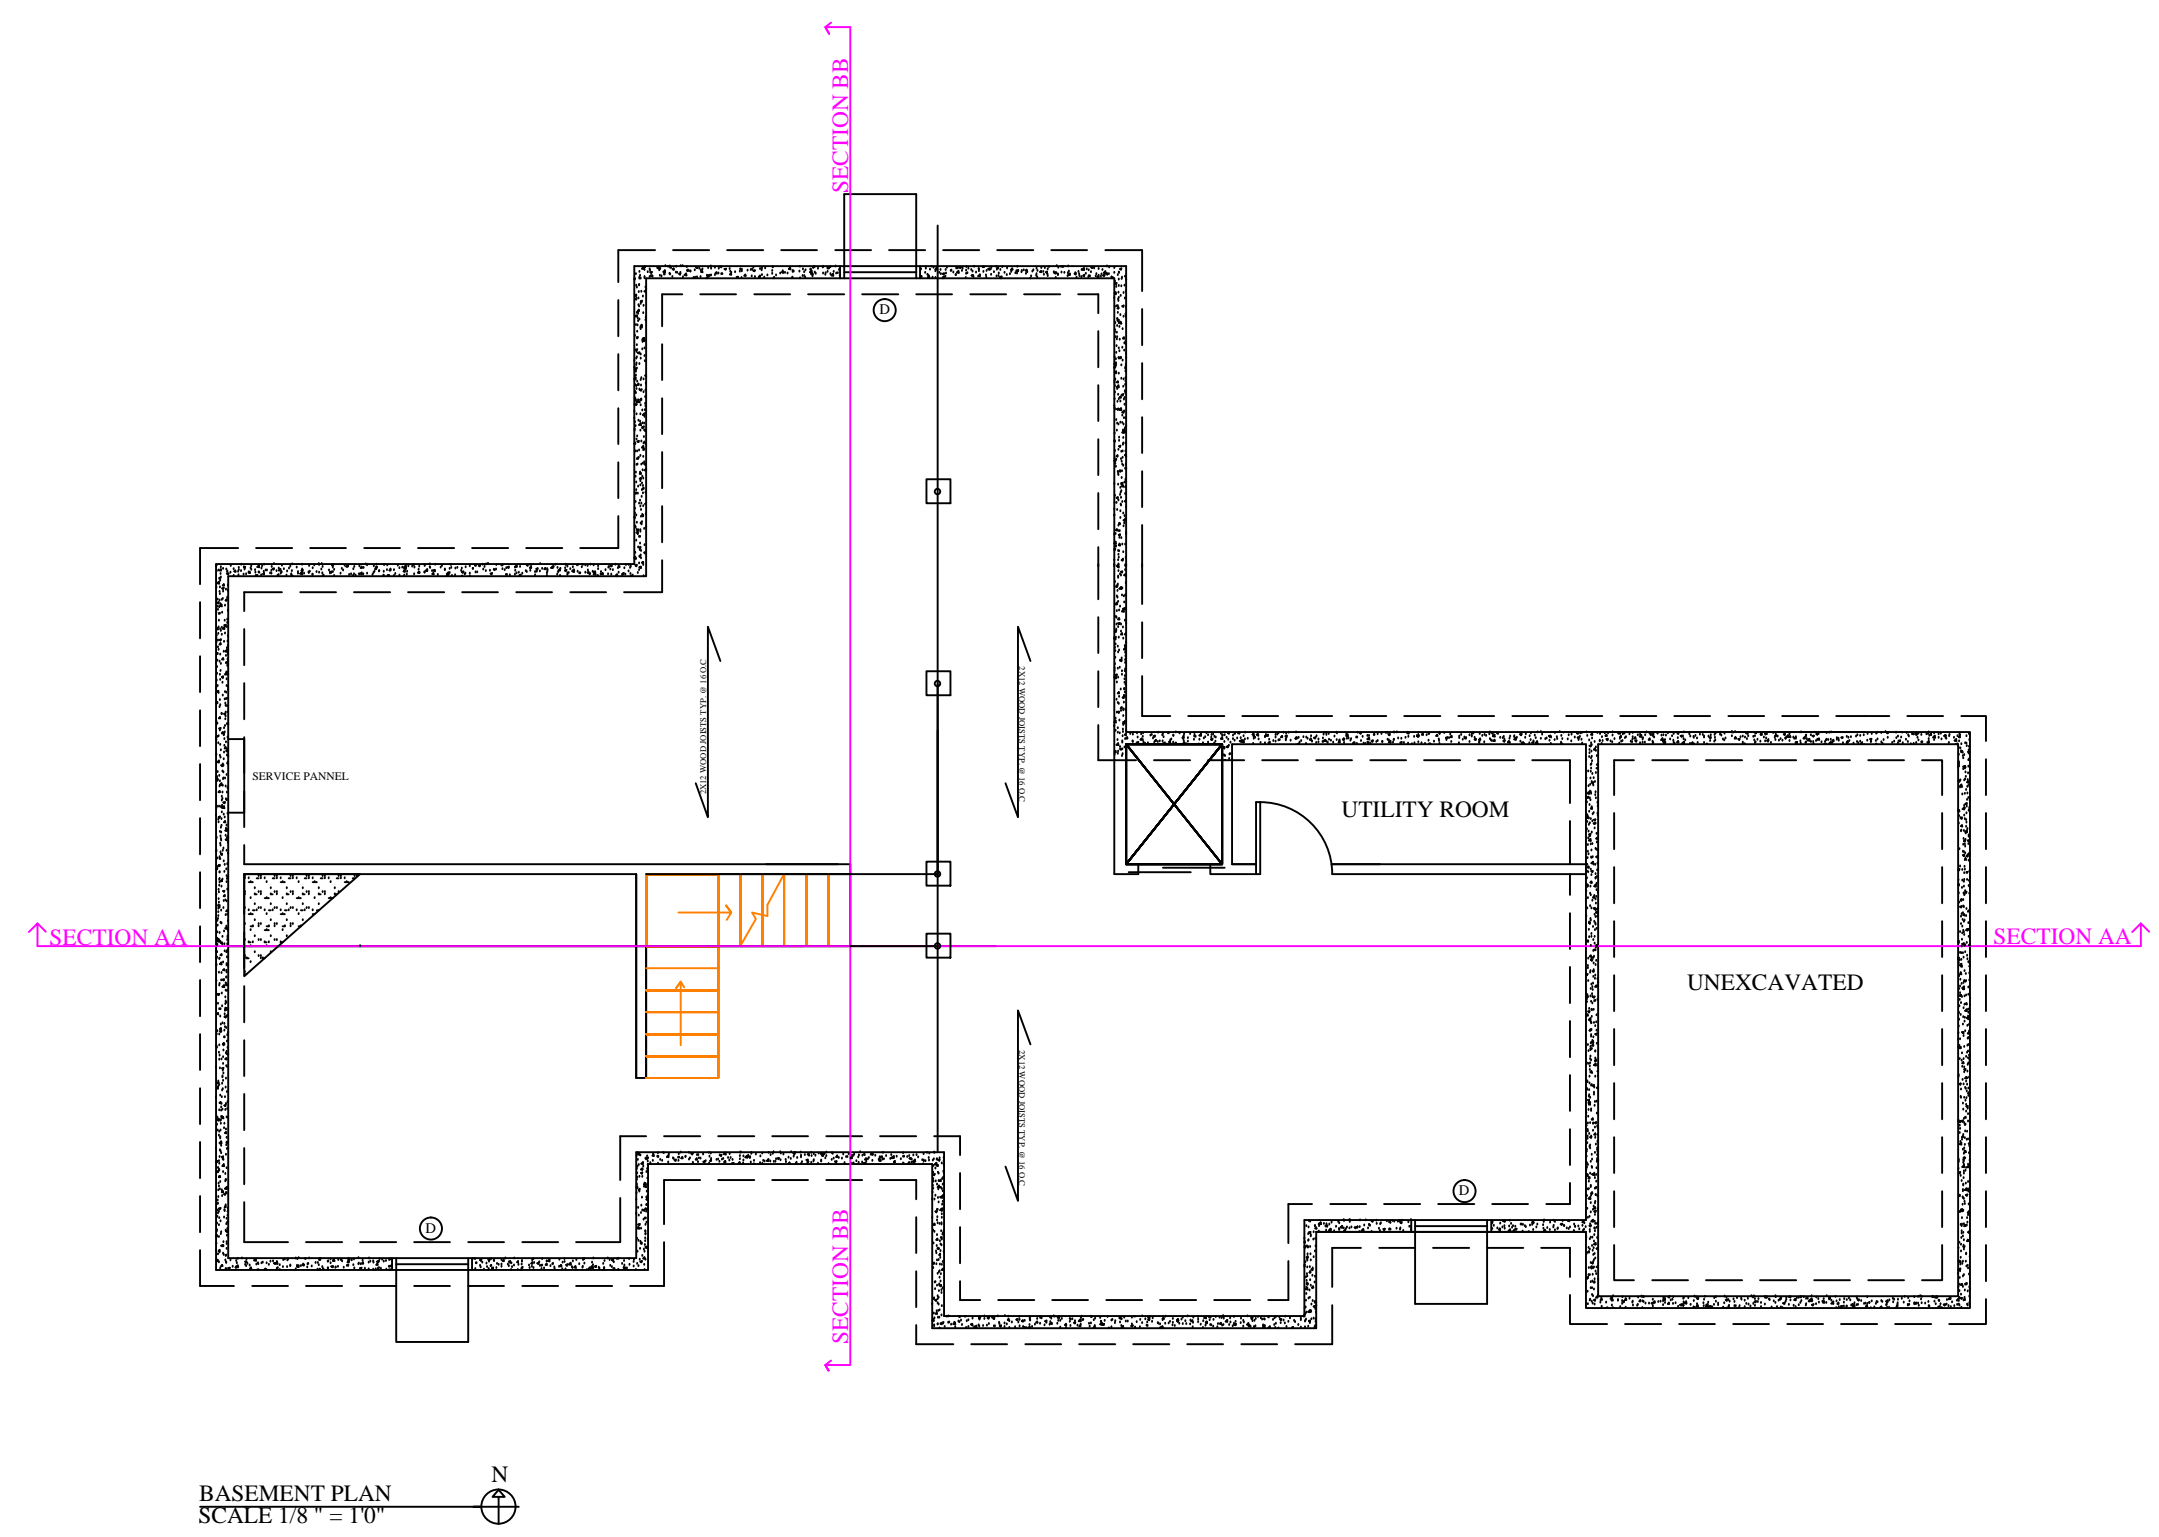


BASEMENT PLAN SCALE 1/8" = 1'-0"

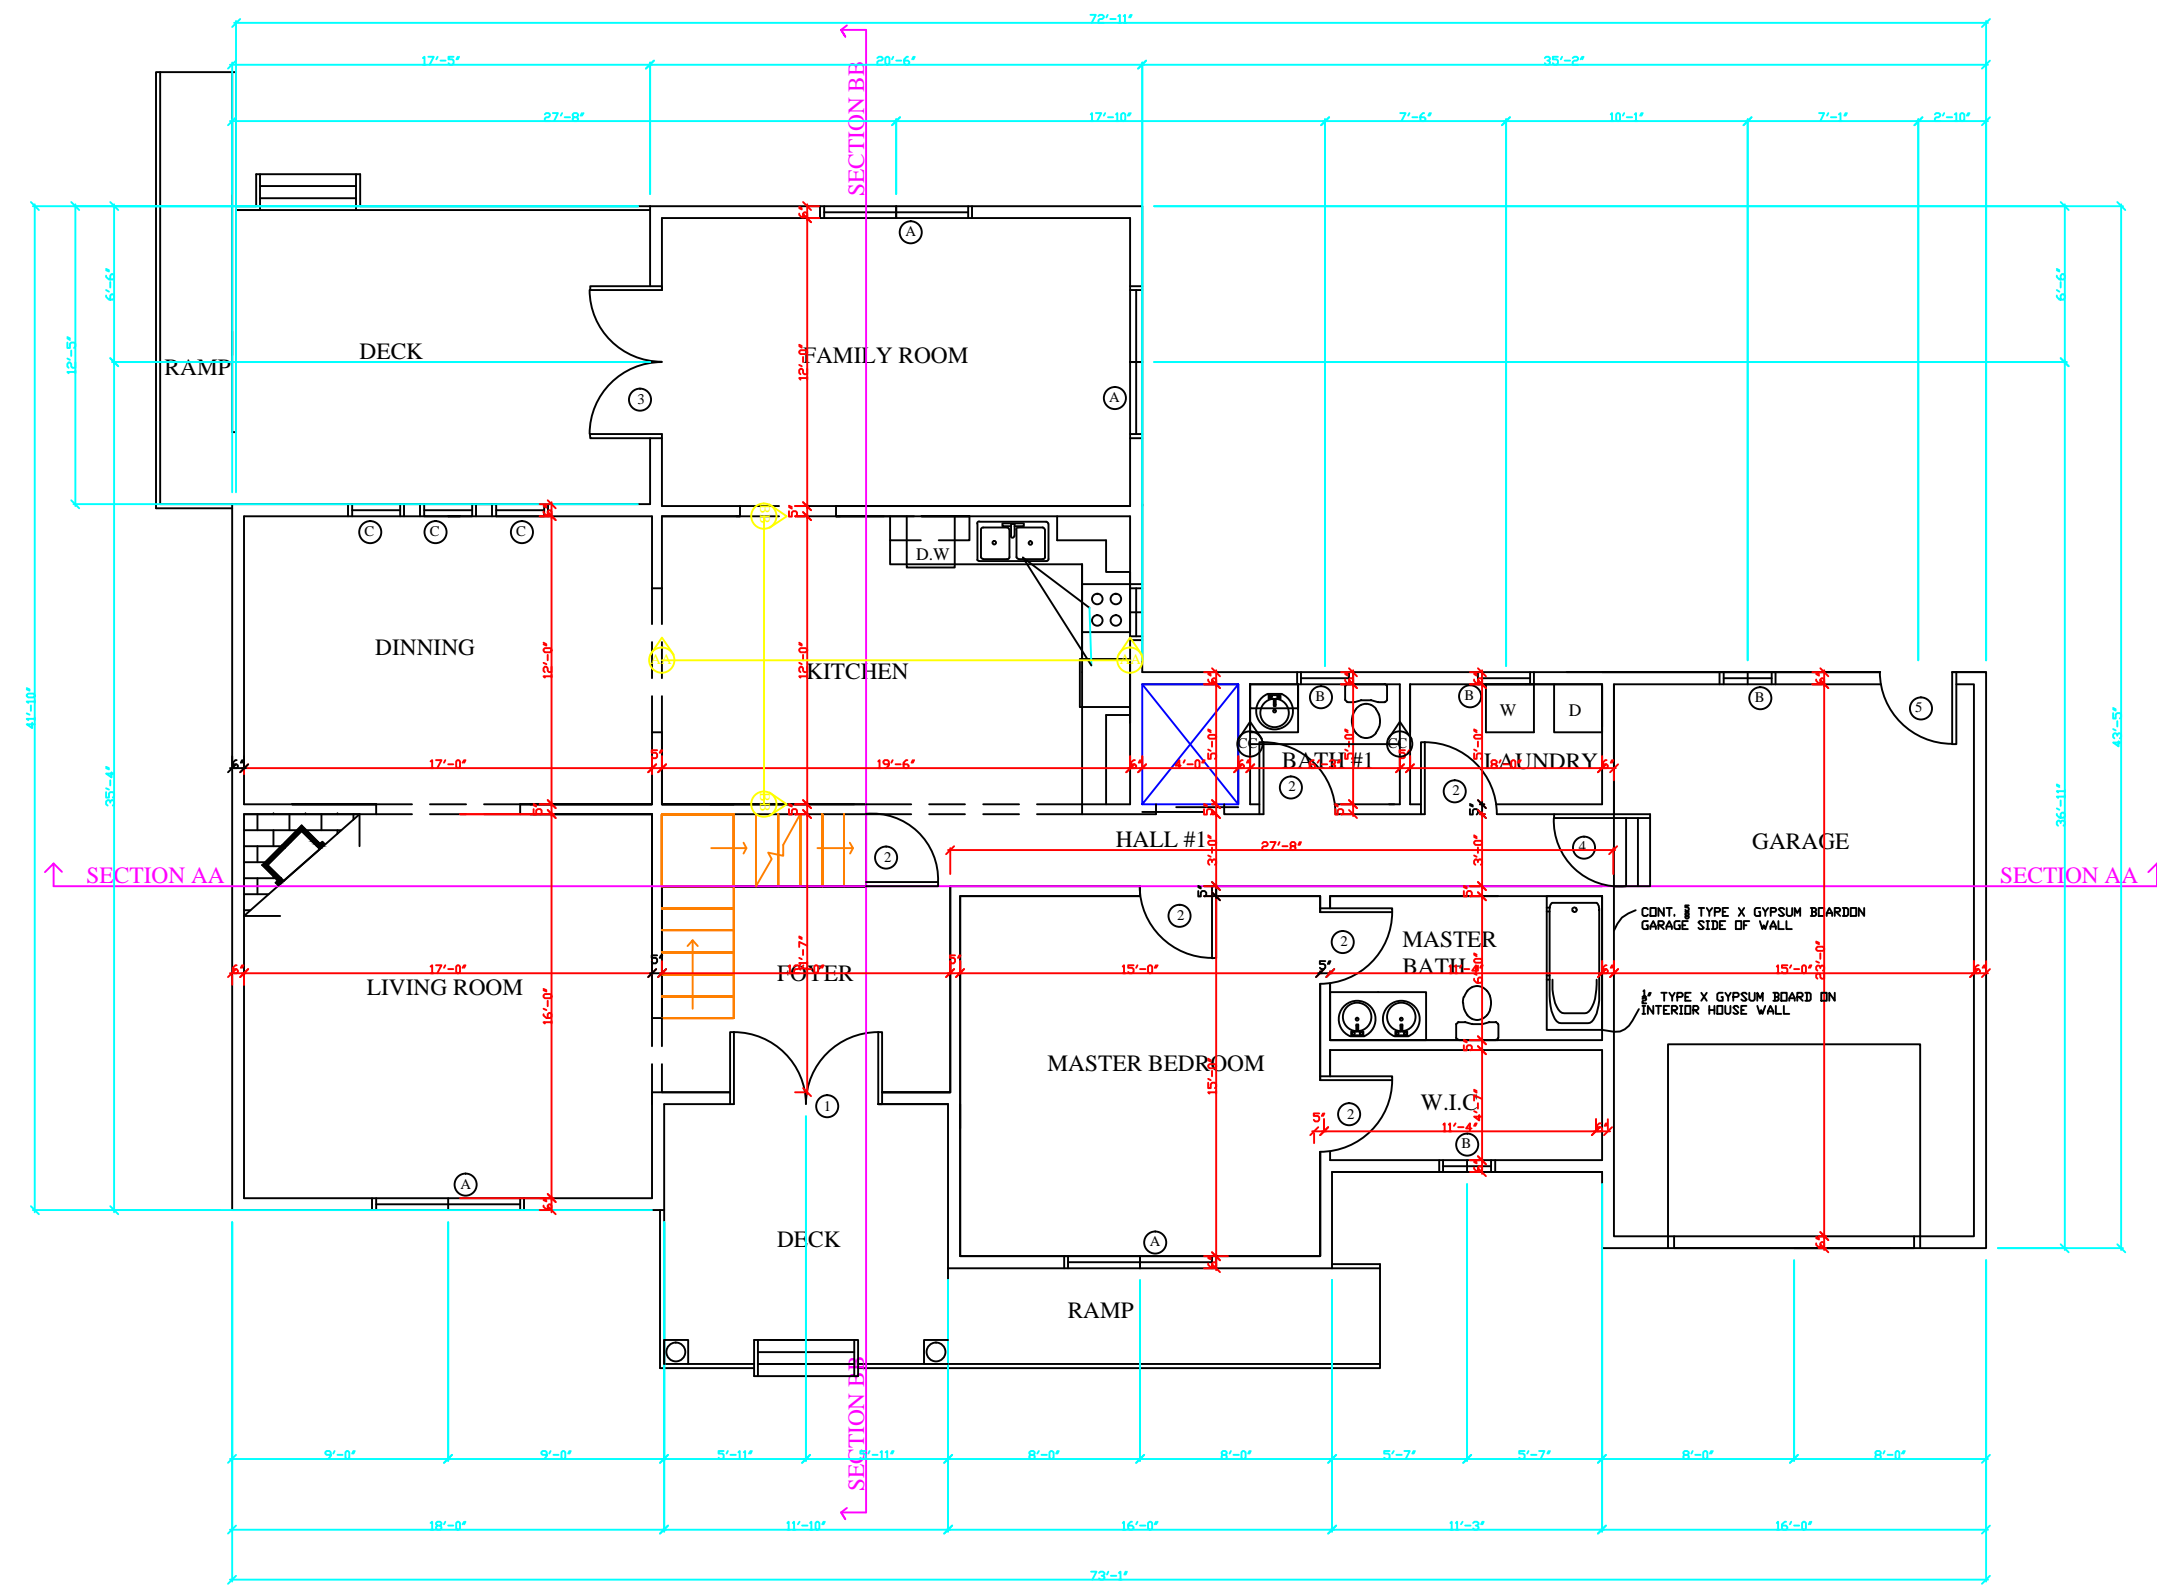

FIRST FLOOR PLAN SCALE 1/8" = 1'-0"

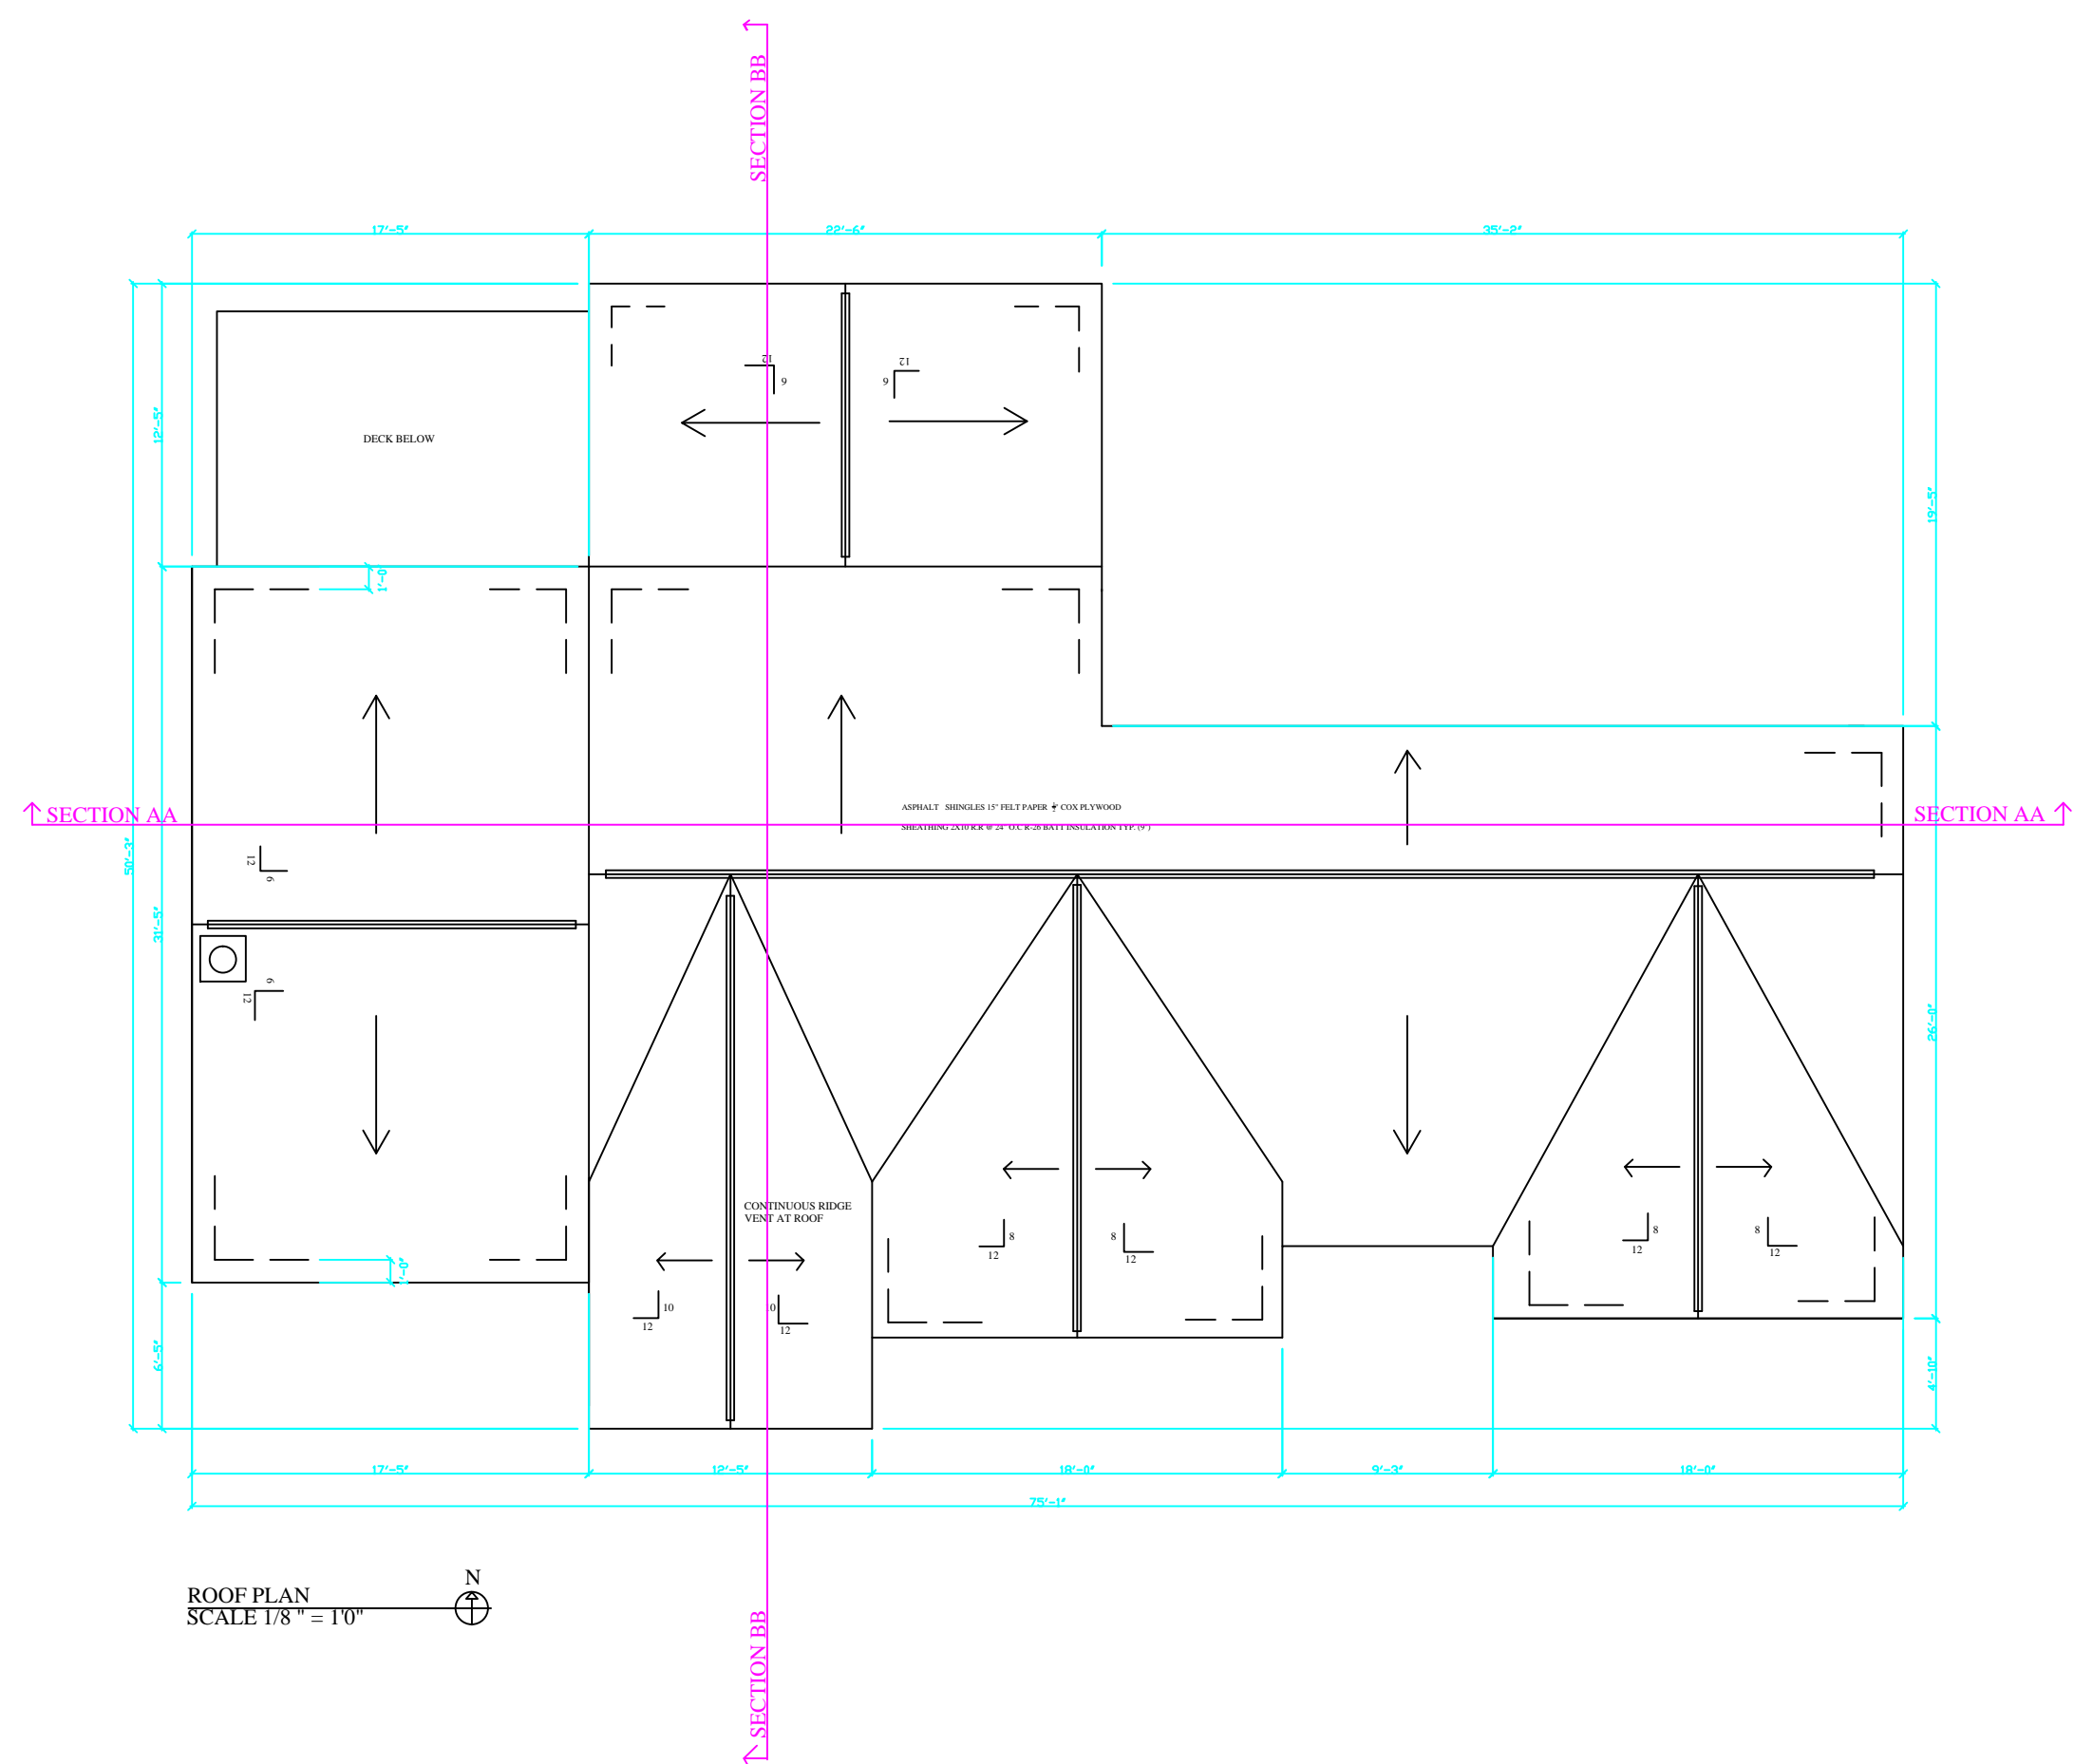

ROOF PLAN SCALE 1/8" = 1'-0"

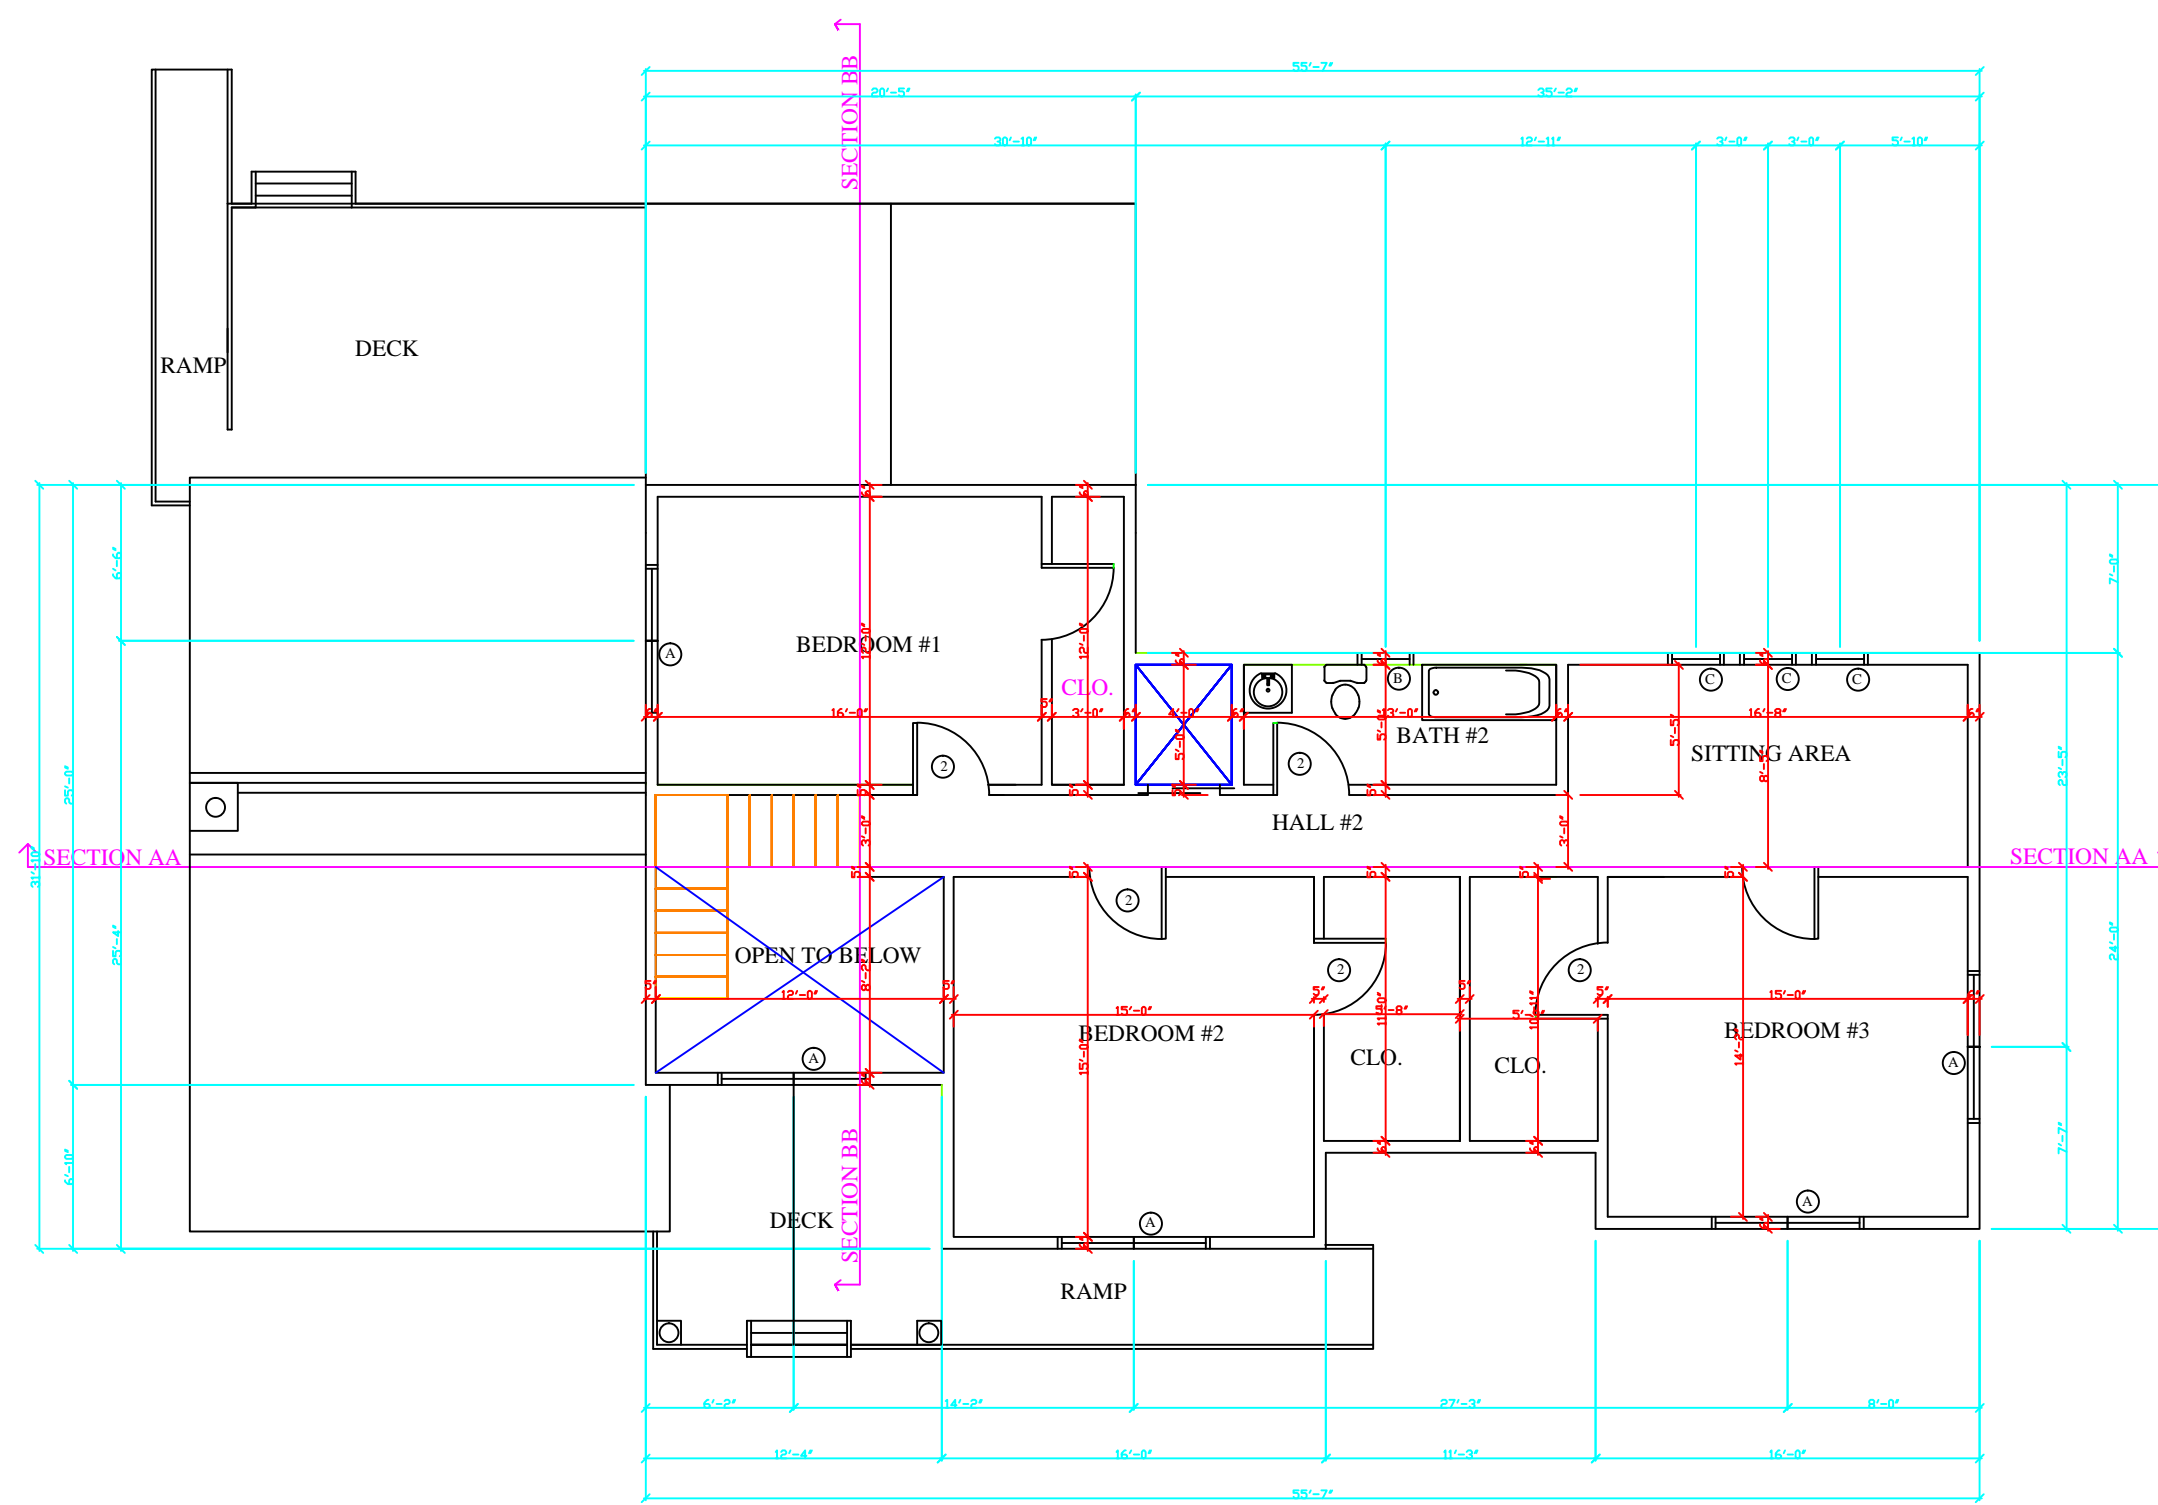

SECOND FLOOR PLAN SCALE 1/8" = 1'-0"

CONSULTANTS

.\fsc-logo-rgb new.jpg

US IMPERIAL PROJECT STREET

OWNER

CLIENT'S NAME Client Street

MARK	DATE	DESCRIPTION








PROJECT NO: 1  
 CAD DWG FILE: MP RESIDENTIAL HOUSE.DWG  
 DRAWN BY: MEGAN PISCIOTTA  
 CHK'D BY: ###  
 COPYRIGHT:

CONSTRUCTION DESIGN SPRING 2014: PROJECT 1

A-02

SHEET SHEET INDEX OF TOTAL SHEETS



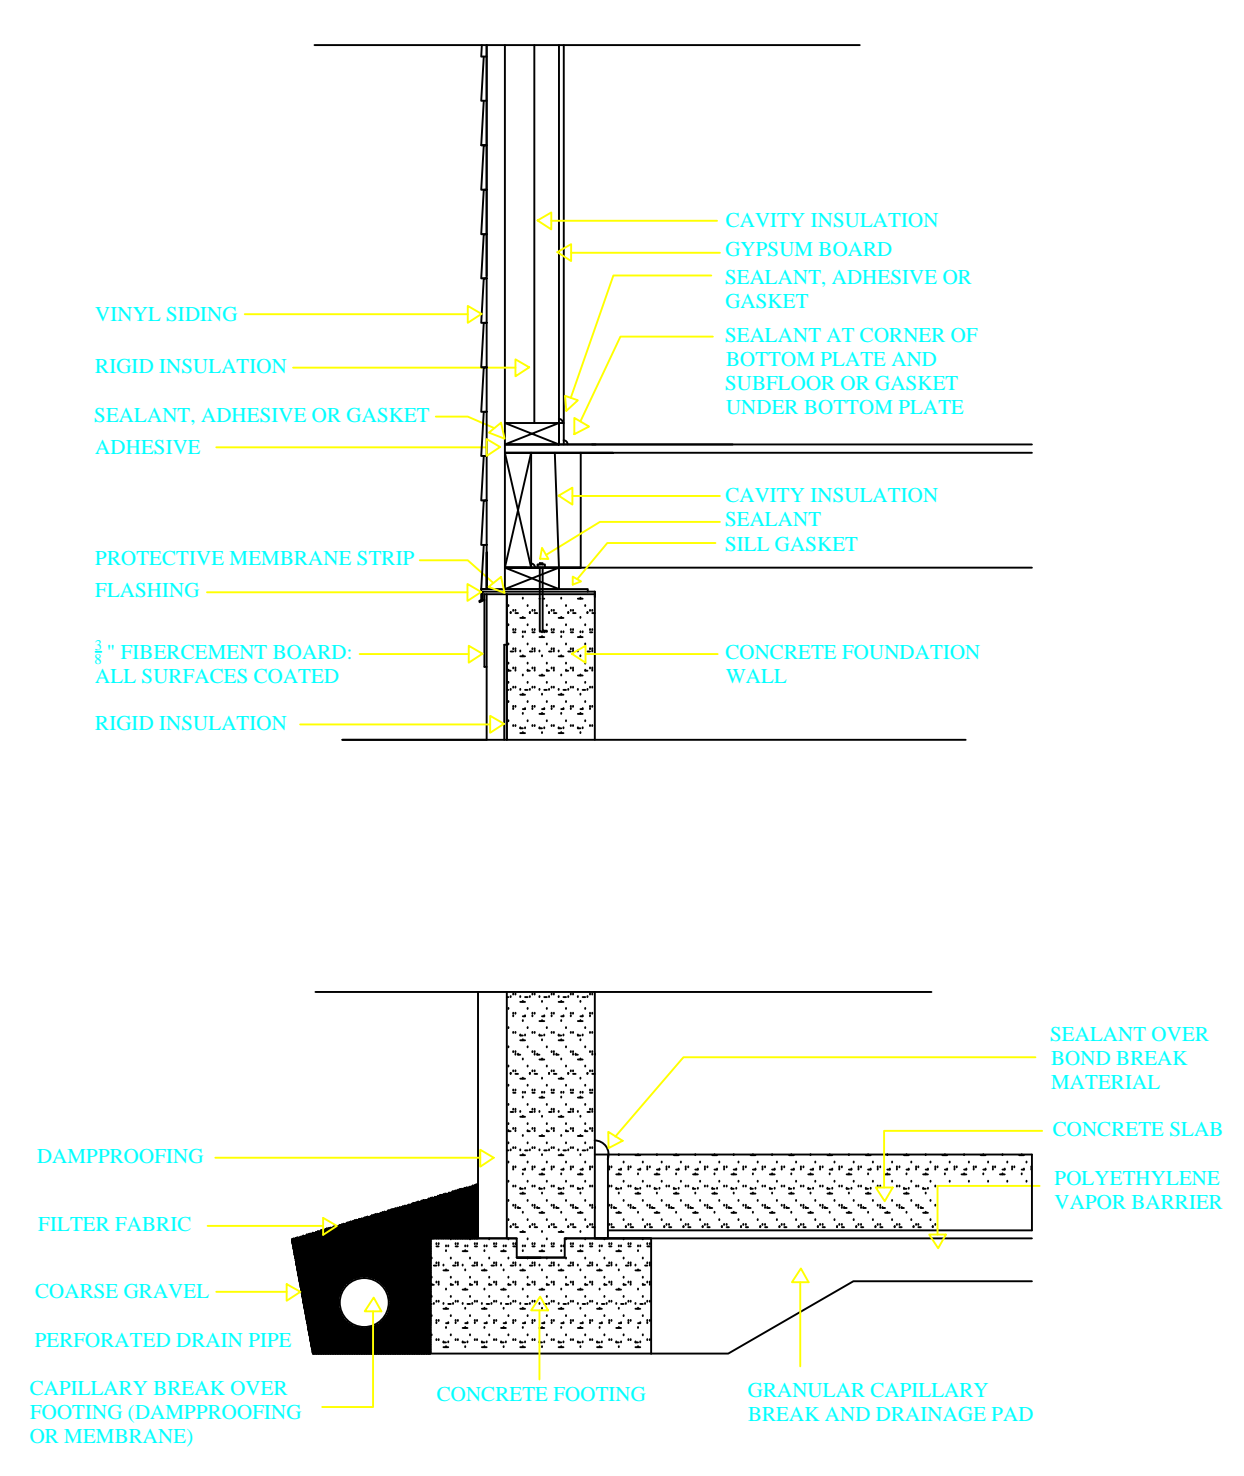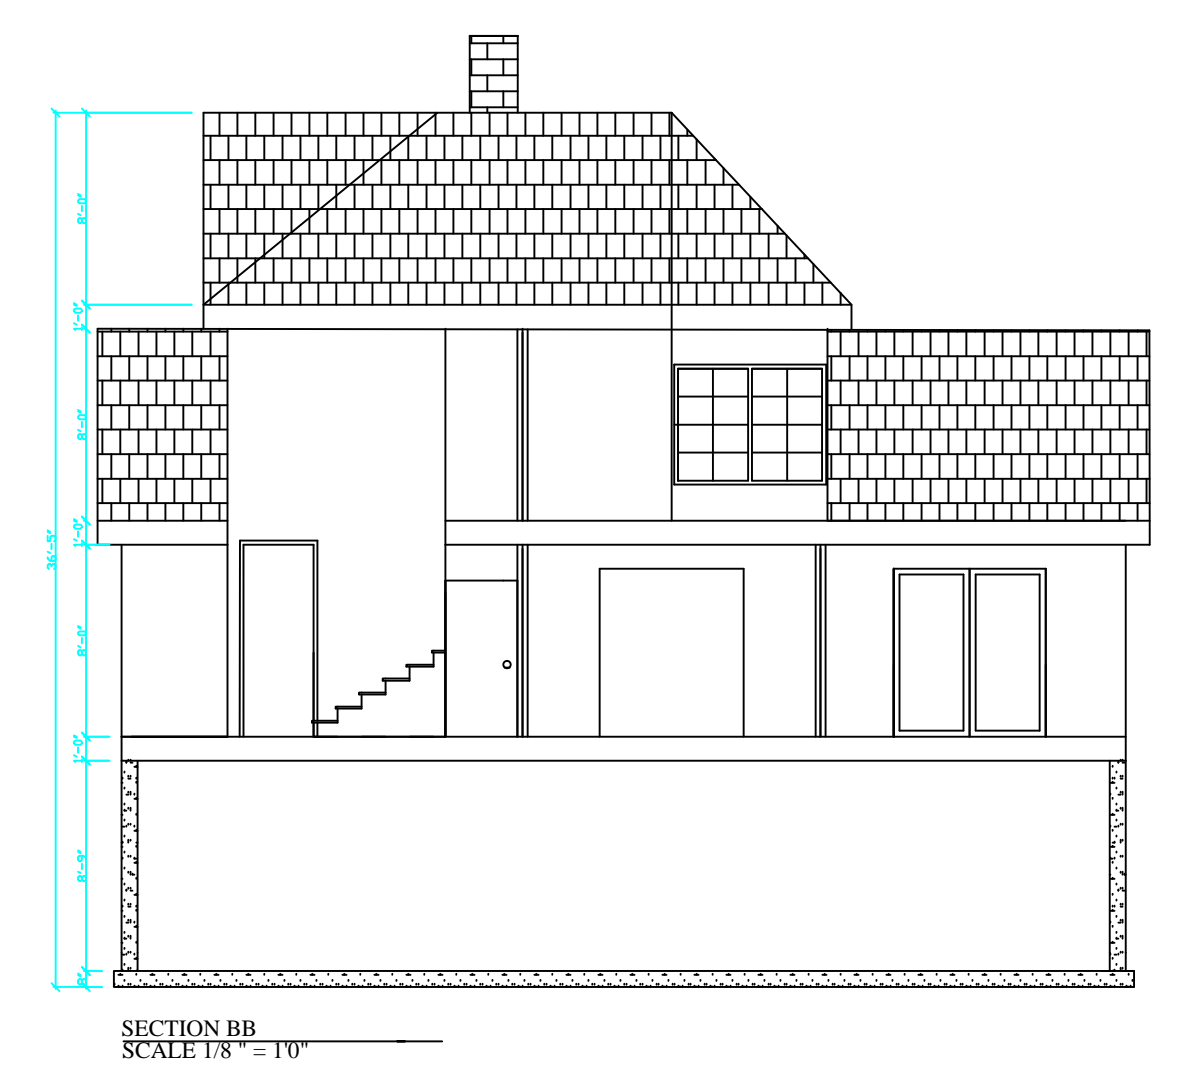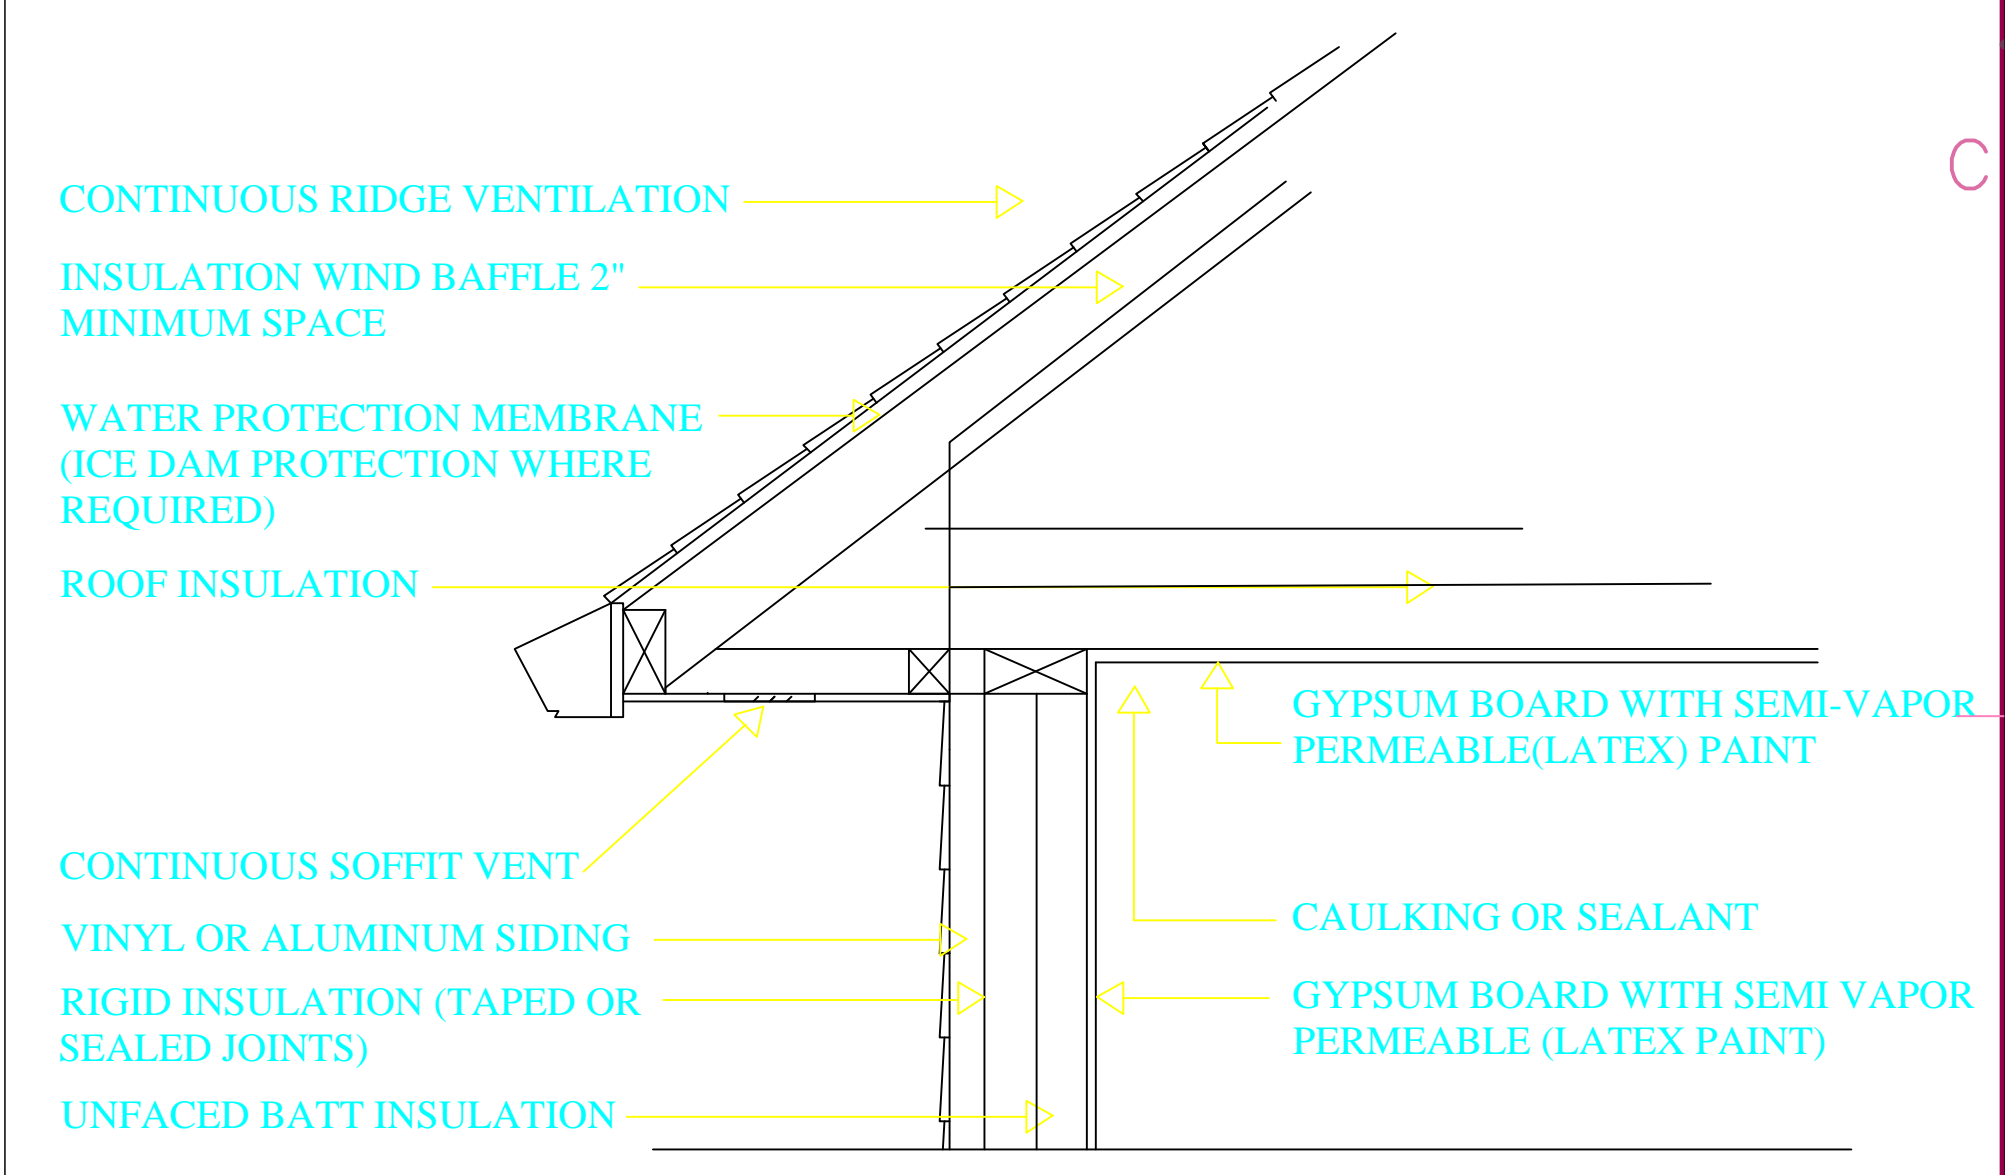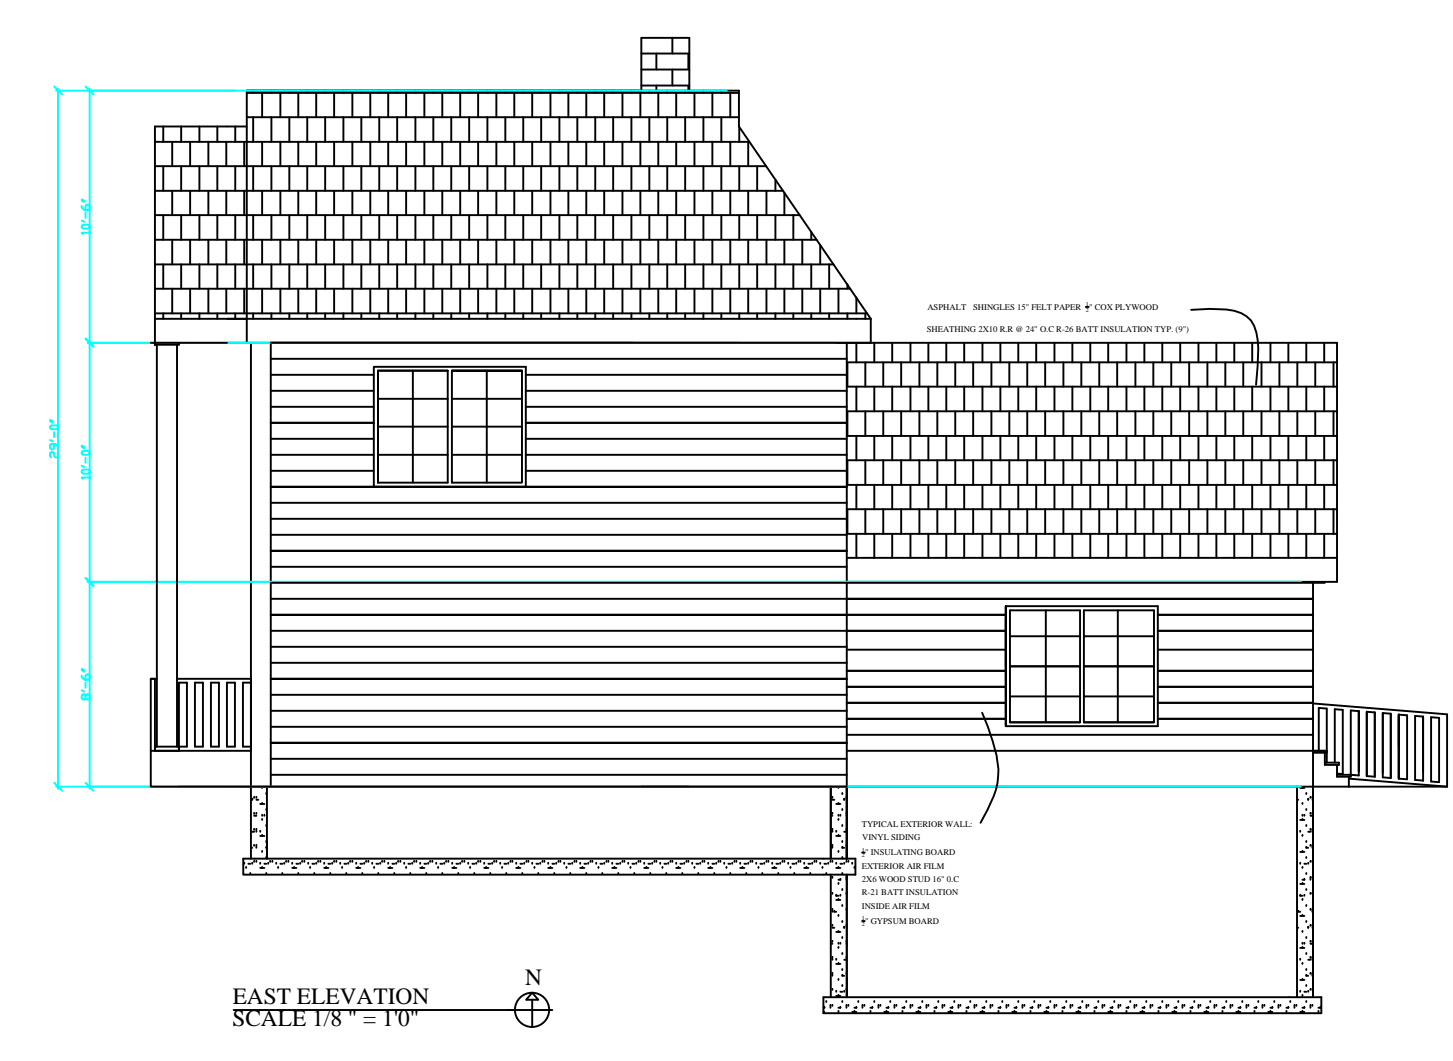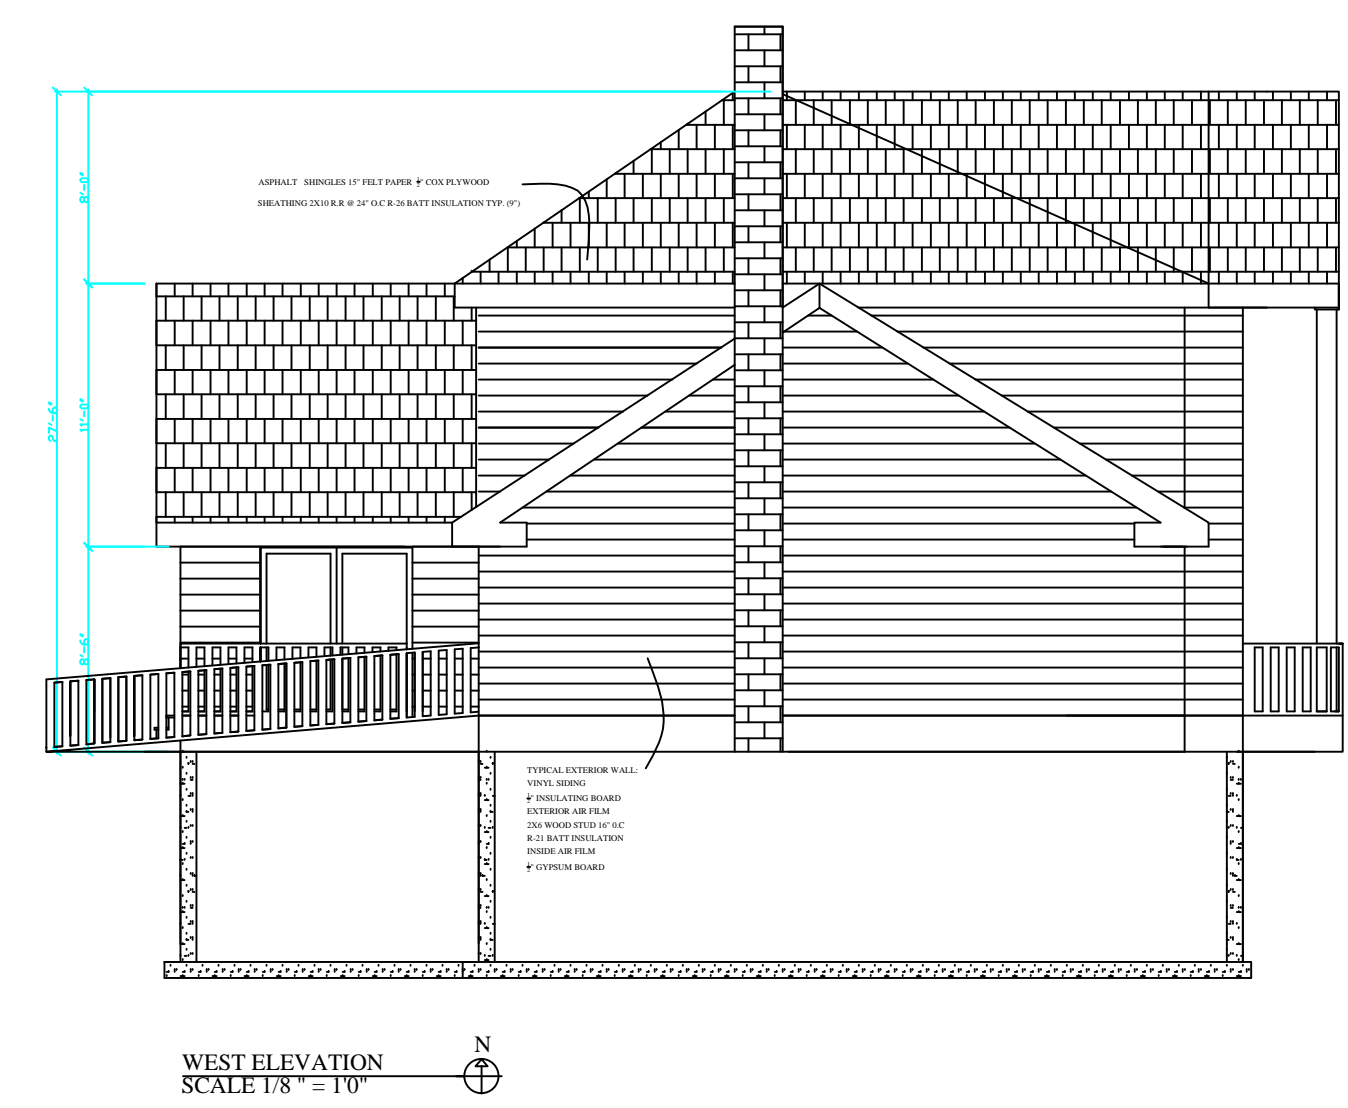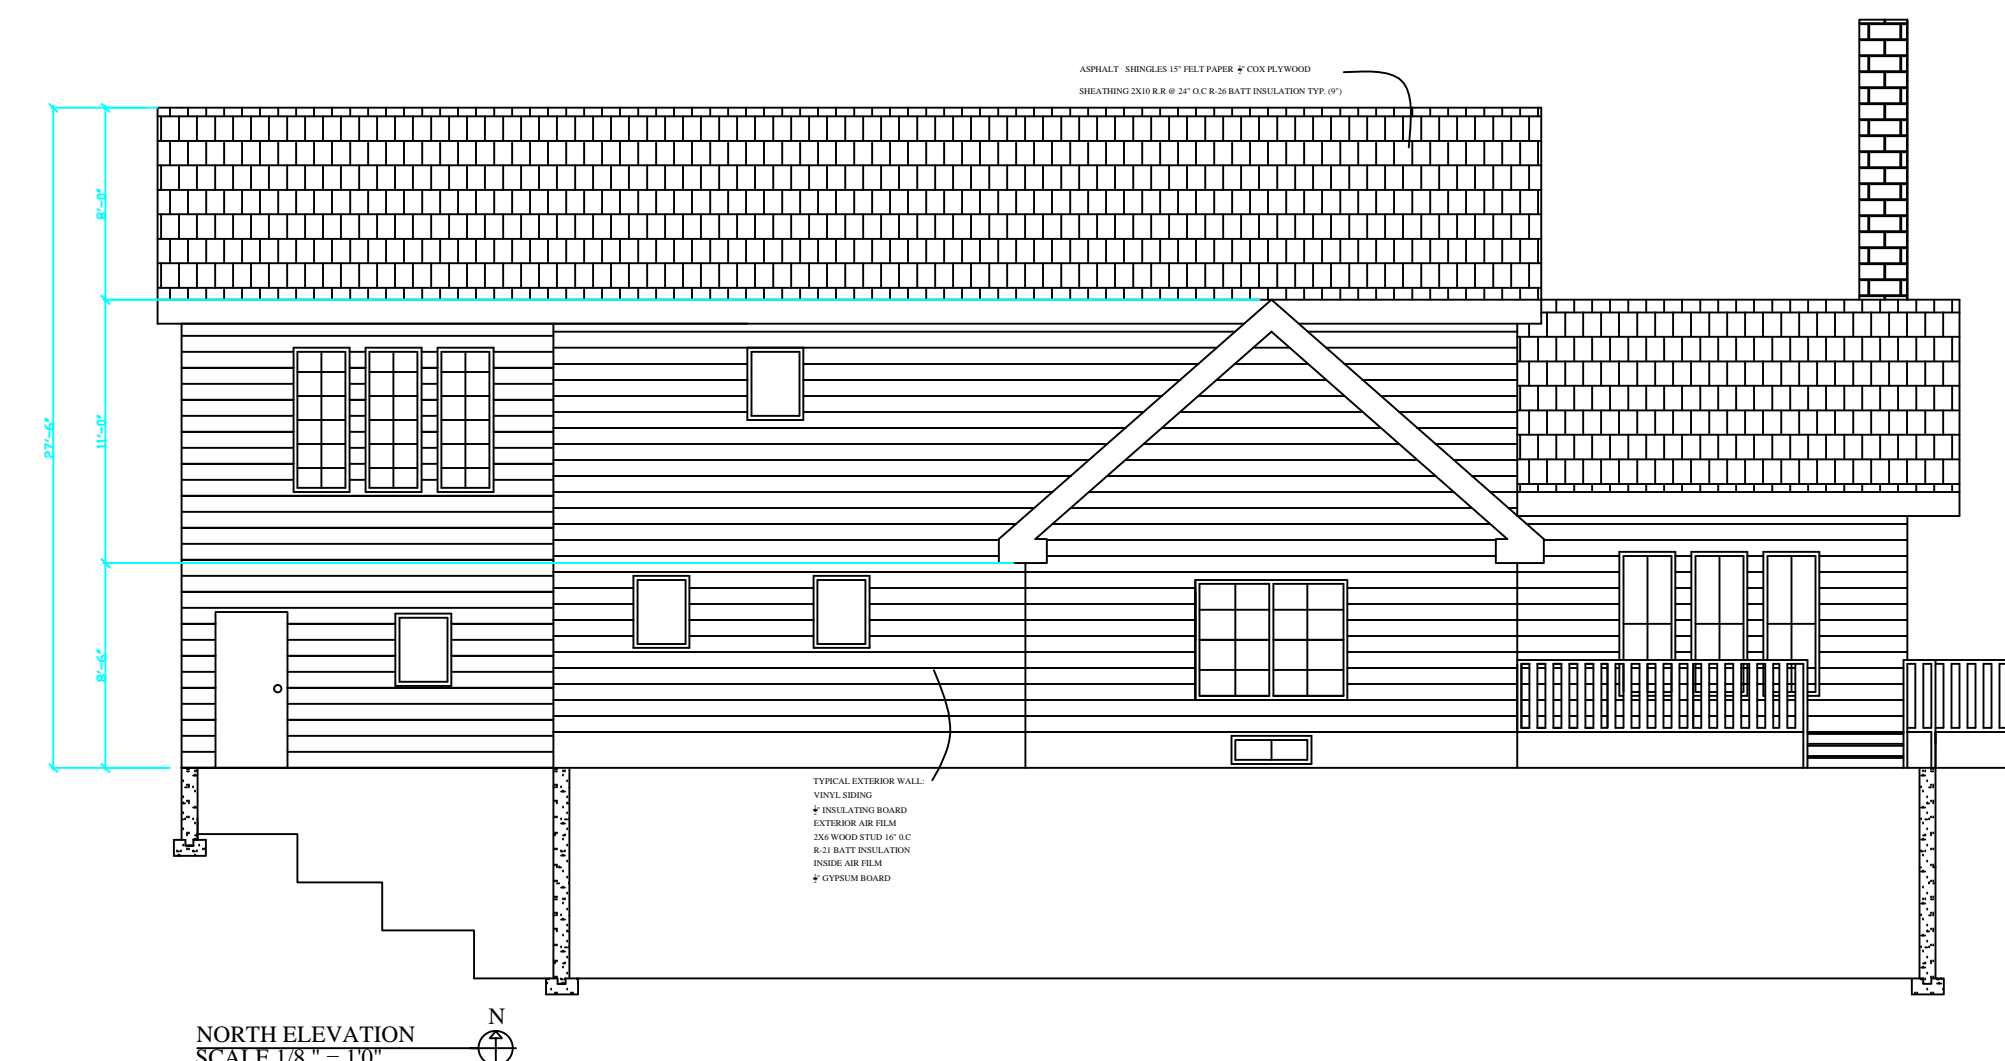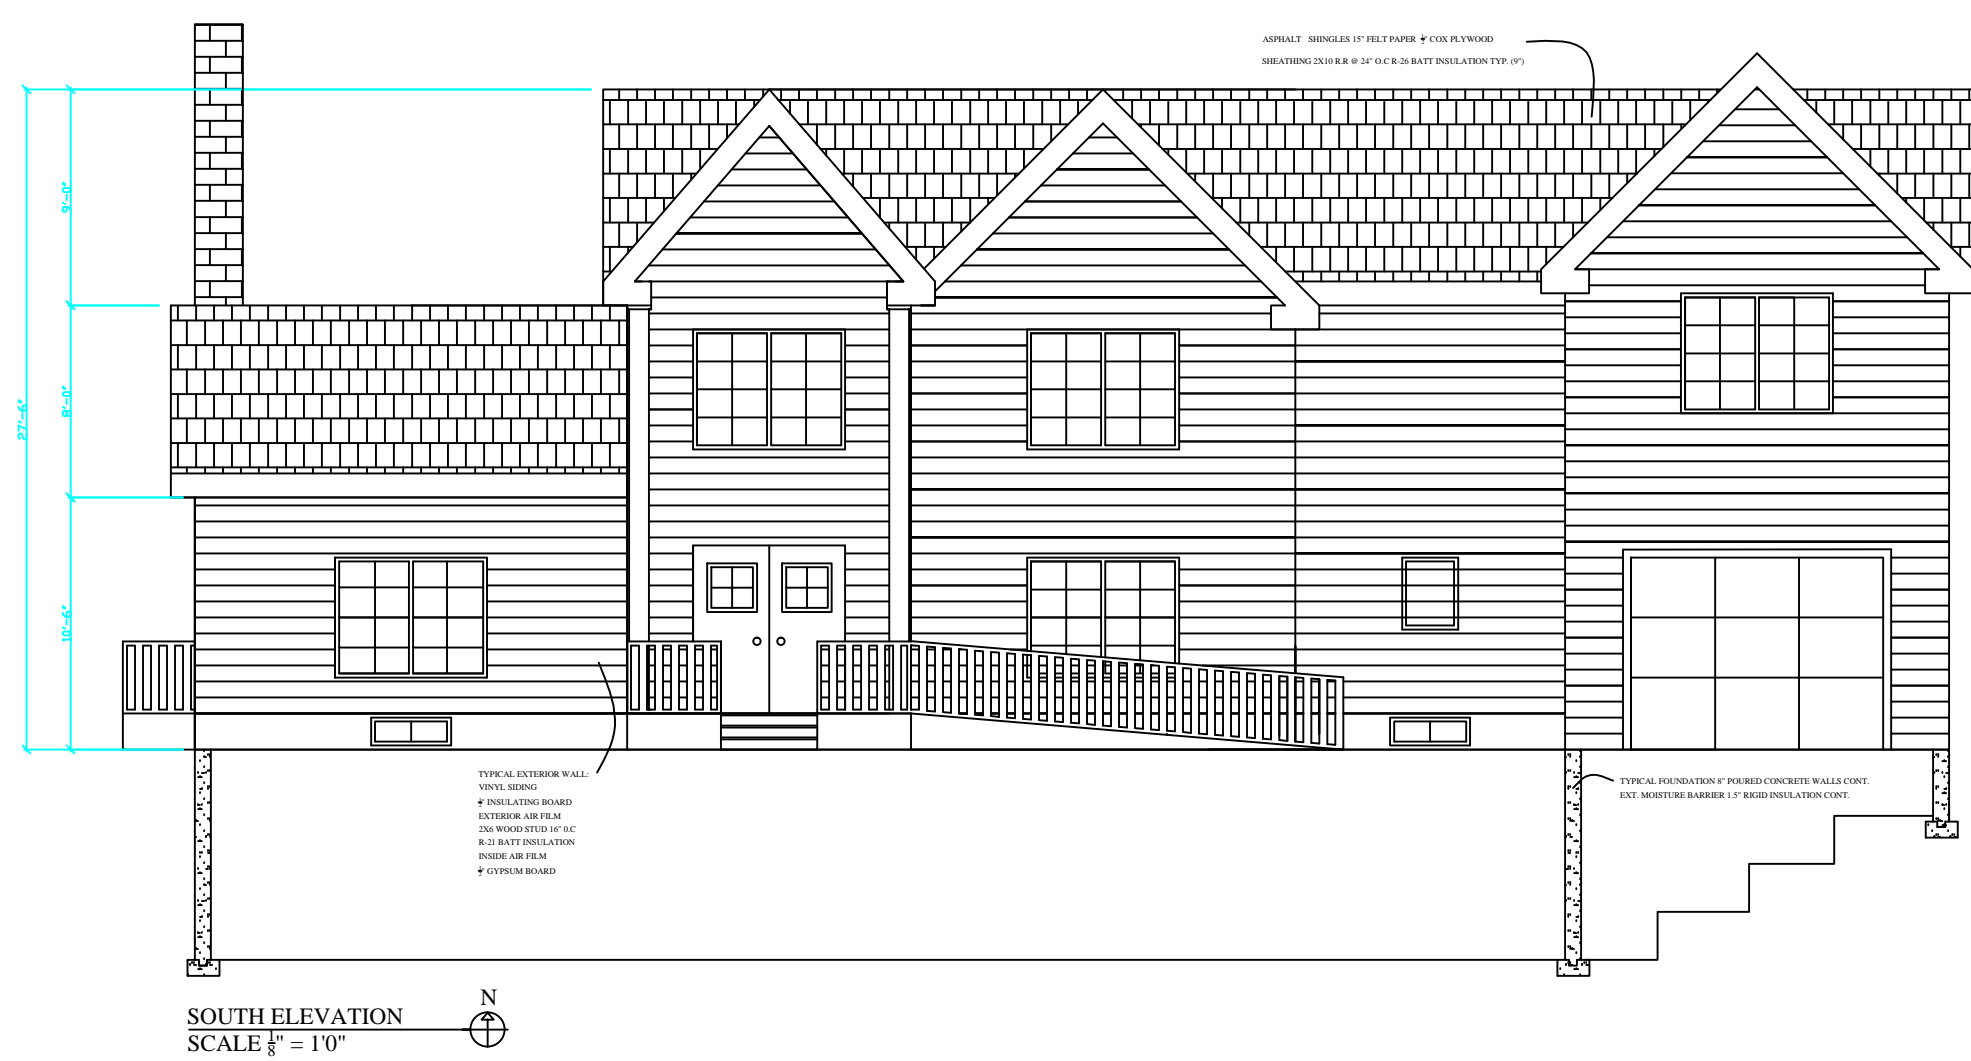

CONSULTANTS

.\\fsc-logo-rgb new.jpg

US IMPERIAL  
PROJECT STREET  
OWNER  
CLIENT'S NAME  
Client Street

MARK DATE DESCRIPTION

PROJECT NO: 1  
 CAD DWG FILE: MP\_RESIDENTIAL\_HOUSE.DWG  
 DRAWN BY: MEGAN PISCIOTTA  
 CHK'D BY: ###  
 COPYRIGHT:

CONSTRUCTION DESIGN  
SPRING 2014: PROJECT 1

A-03

SHEET SHEET INDEX OF TOTAL SHEETS

PRODUCED BY AN AUTODESK EDUCATIONAL PRODUCT

PRODUCED BY AN AUTODESK EDUCATIONAL PRODUCT